www.phoenixoregon.gov

541-535-2050



Type II/III Application

OFFICIAL U	JSE ONLY
File #	Fee Paid
Date Received	Receipt #
Received by	

							eceived by			ot #
Location	Site	Address						Zone		
Loca	Tow	nship / Range 38-1W-	Section(s)		Tax Lot(s)			Overlay(s)	
		Name								
	Owner	Mailing address	;				City		State	Zip
Ó	•	Phone				Email				
ŧ	nt	Name								
Contact	Applicant	Mailing address	;				City		State	Zip
	4	Phone					Email			
		Name								
	Agent	Mailing address	;				City		State	Zip
		Phone					Email			
		Appeal					Site De	sign Revie	2W	
Project Type		Conditional Us	se				Variand	ce		
ect T		Floodplain De	velopment				Zoning	Map Char	nge	
roje		Modification t	:o Approval							
	Brie	ef Description								
ed tals		Plot Plan / Site	e Plan							
Required Submittals		Applicant Narrative (addressing all applicable Phoenix Land Development Code requirements)								
Re		Supplemental	Information (as r	necessa	ry)					
Consent &	I hereby state that the facts related in the above application and the plans and documents submitted herewith are complete, true, correct, and accurate to the best of my knowledge.									
Cor	Sigi	nature*					Арр	licant	Agent	Owner

^{*} This application must be signed by the property owner to demonstrate consent. Alternatively, a Letter of Authorization on City letterhead may be accepted.

Willard Williams, AIA, NCARB

P.O. Box 4460, Medford, Oregon, 97501

541.326.6247

City of Phoenix Planning Department-Land Use Application

For Pacific Wall Systems

Project Address: 100 Houston Road, Phoenix OR

TAX LOT: 38-1W-90DC 3700

SECTION 1 – Narrative

The project involves an addition to an existing metal building and the construction of a new

metal structure for assembly and fabrication. Both new structures will be open-sided with a

covered roof. The site is part of a General Industrial development located off Houston Road.

This proposal represents a minor revision to the previously approved project, as it does not

adversely impact adjacent properties, increase access ways, reduce setbacks, or introduce

other modifications that would constitute a major change.

As part of these site adjustments, we have made minor modifications to the landscaping plan

(Ch. 3.3) to improve on-site maneuverability. Additionally, we have refined the internal access

layout (Ch. 3.2) by adjusting the previously proposed access for larger transportation vehicles.

The footprint of the previously approved building (Ch. 2.5) has also been slightly modified,

though its design is still being finalized. In the interim, we are proposing two smaller structures

to ensure operational continuity during construction. Maintaining uninterrupted operations is

critical to the ongoing success of the business, and this phased approach allows for a seamless

transition while the new buildings are completed.

SECTION 2 - Site Plan

See Site Plan

<u>SECTION 3 – Additional information</u>

1. Number of acres in development: 8.73 Acres (380,279 sq. ft.)

City of Phoenix Planning Department Land Use Application

- 2. Total gross square footage of existing structures: 63,664 sq. ft.
- 3. Total proposed square footage of new structures Phase 1: 14,088 sq. ft. (ref. site plan)
- 4. (E) Wall Fabrication Shop- 1-story 47,275 sq. ft.
- 5. (E) Floor Fabrication Shop and Lumber Preparation- 1-story 4,630 sq. ft.
- 6. (E) Lumber Storage- 1-story 6,900 sq. ft.
- 7. (E) Office Space- 1-story 2,482 sq. ft.
- 8. (E) Office Space- 1-story 2,379 sq. ft.
- 9. Proposed Metal Buildings:
 - a. Building 1: TBD
 - b. Building 2: (E) 3,200 sq. ft. (N) 3,280 sq. ft. = Total 6,480 sq. ft.
 - c. Building 3: (N) 7,688 sq. ft.
- 10. Indicate number of and square footage of:
 - a. Dwelling units: N/A
 - b. Office spaces: (E)(2)- 4,860 sq. ft.
 - c. Retail units: N/A
 - d. Other Spaces: Industrial spaces 73,000 sq. ft.
- 11. Percentage of lot coverage by:
 - a. Structures: 26 %
 - b. Streets & Roads: N/A
 - c. Parking Areas/ Driveways: 26 %
 - d. Recreation Areas: N/A
 - e. Landscaping existing: none
 - f. Number of parking spaces: 55 provided
 - g. Total square footage of landscaped areas proposed: 47,000 sq. ft. Approximately, 15,000 sq. ft. Gravel, and 9,200 sq. Ft. Hardscape.
 - h. Other pertinent information of the proposed development: N/A


Prepared by:



Signature and Title


Willard E. Williams Jr., NCARB, AIA

City of Phoenix Planning Department- Land Use Application

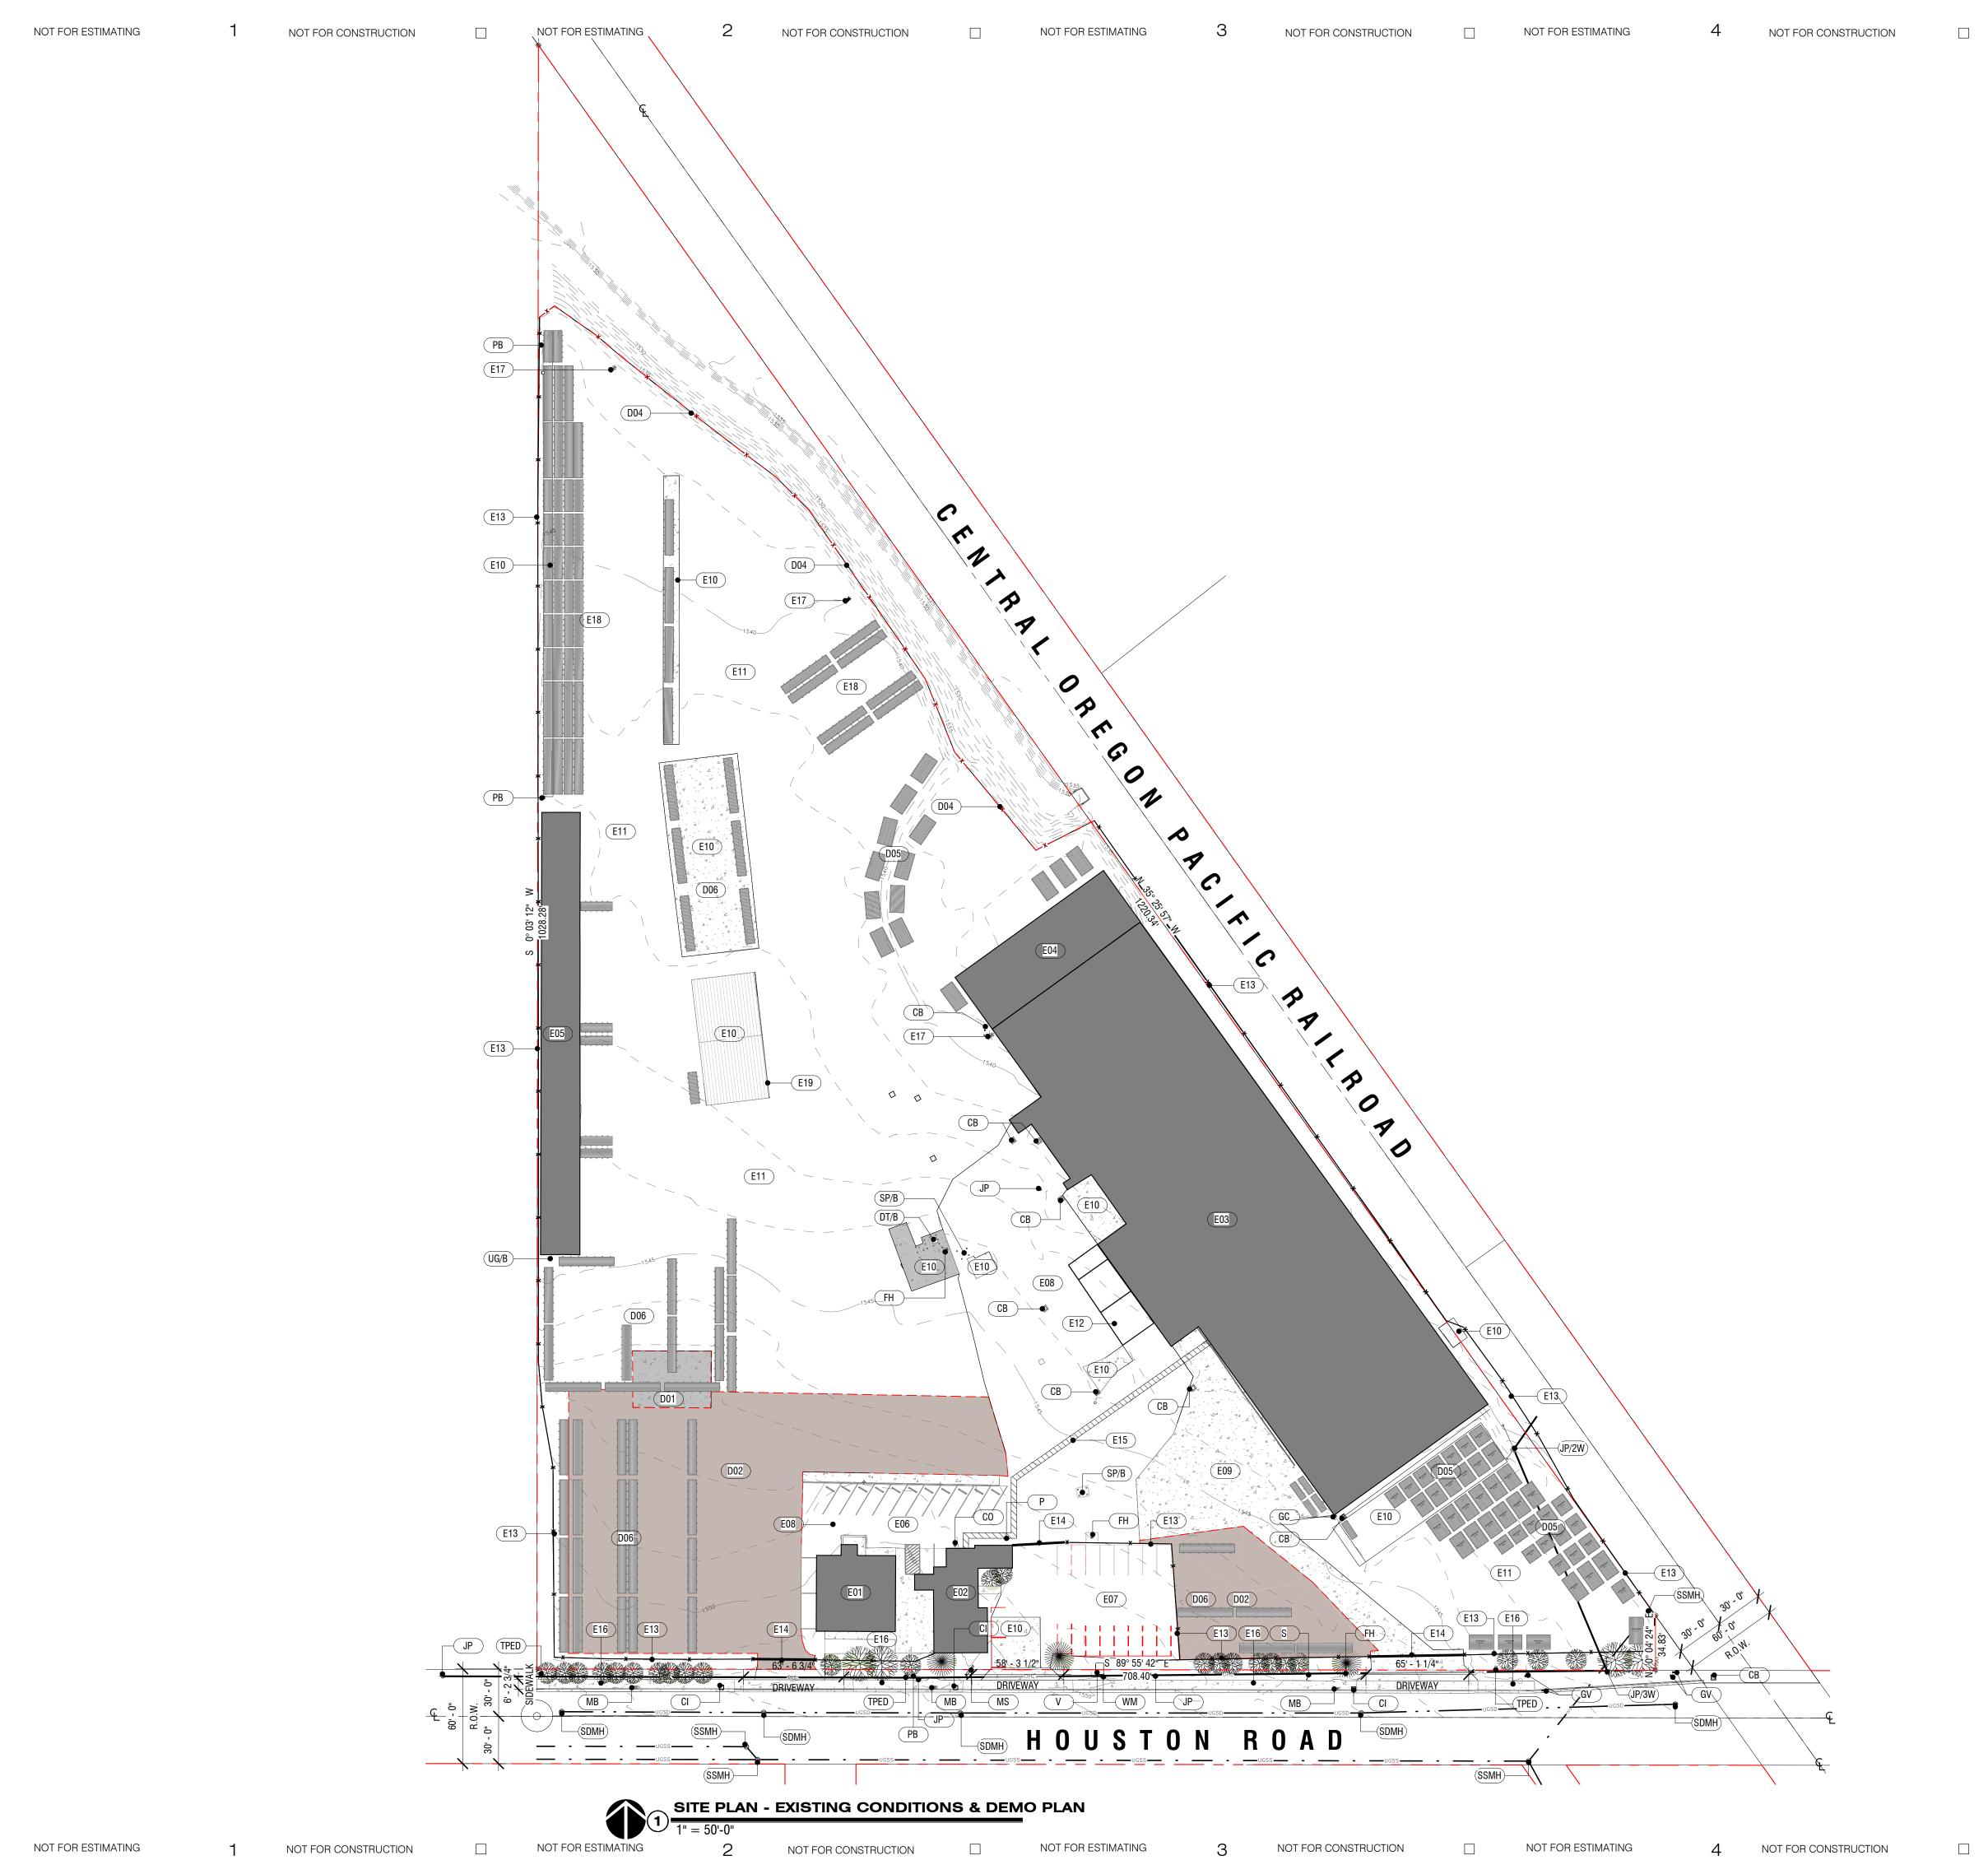

LEGEND - DEMO

NOT FOR ESTIMATING

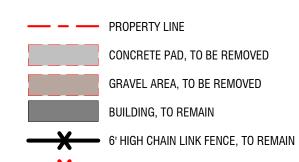

— 💥 — 6' HIGH CHAIN LINK FENCE, TO BE RELOCATED EXISTING VEGETATION, TO REMAIN

KEYNOTE - SURVEY LEGEND KEYNOTE DESCRIPTION

NOT FOR CONSTRUCTION

KLINUIL	DESCRIPTION
CB	CATCH BASIN
CI	CURB INLET
CO	CLEANOUT
DT/B	DIESEL TANK W/ BOLLARDS
FH	FIRE HYDRANT
GC	GAS CONNECT
GV	GAS VALVE
JP	JOINT POLE
JP/2W	JOINT POLE W/ 2 GUYS
JP/3W	JOINT POLE W/ 3 GUYS
MB	MAILBOX
MS	MONUMENT SIGN
Р	POLE
PB	PULLBOX
S	SIGN
SDMH	STORM DRAIN MANHOLE
SP/B	STAND PIPE WITH BOLLARDS
SSMH	SANITARY SEWER MANHOLE
TPED	TELECOMMUNICATION PEDESTAL
UG/B	UNDERGROUND ELECTRICAL W/ BOLLARDS
V	VAULT
WM	WATER METER

* SURVEY LEGEND SHOWN IN THIS PLAN IS FOR REFERENCE ONLY, SEE TOPOGRAPHIC SURVEY BY HOFFBUHR & ASSOCIATES, INC., DATED MARCH 7, 2024.

KEYNOTE - DEMO SITE CONDITIONS

KEYNOTE DESCRIPTION

NOT FOR ESTIMATING

NOT FOR CONSTRUCTION

D01	CONCRETE PAD, TO BE REMOVED
D02	GRAVEL AREA, TO BE REMOVED
D04	EXISTING 6' HIGH CHAIN LINK FENCE, RELOCATE TO EDGE OF PROPERTY LINE
D05	EXTERIOR RAW MATERIAL STORAGE, TO BE RELOCATED TO THE BACK OF THE PROPERTY
D06	EXTERIOR FINISH PRODUCT STORAGE, TO BE RELOCATED TO THE BACK OF THE PROPERTY

KEYNOTE - EXISTING SITE CONDITIONS

KEYNOTE DESCRIPTION E01 EXISTING ONE-STORY COMMERCIAL BUILDING (2,480 SQ FT), TO REMAIN E02 EXISTING ONE-STORY COMMERCIAL BUILDING (2,379 SQ FT), TO REMAIN E03 EXISTING WALL FABRICATION BUILDING (47,275 SQ FT), TO REMAIN E04 WALL FABRICATION - REPAIR IN SEPARATE PERMIT E05 EXISTING COVERED STORAGE BUILDING (4,210 SQ FT), TO REMAIN E06 EXISTING EMPLOYEE PARKING AREA (13 PARKING SPOTS + 1 ADA SPOT), TO REMAIN EXISTING CUSTOMER/PUBLIC PARKING AREA(18 PARKING SPOTS), TO REMAIN E08 EXISTING ASPHALT CONCRETE PAVEMENT, TO REMAIN E09 EXISTING CONCRETE PAVEMENT, TO REMAIN E10 EXISTING CONCRETE PAD, TO REMAIN EXISTING GRAVEL AREA, TO REMAIN E12 EXISTING LOADING AND UNLOADING AREA FOR WAREHOUSE BUILDING, TO REMAIN EXISTING 6' HIGH CHAIN LINK FENCE, TO REMAIN E14 EXISTING MOTORIZED 6' HIGH SLIDING GATE, TO REMAIN EXISTING STRIPPED PEDESTRIAN CROSSWALK, TO REMAIN E16 EXISTING SIDEWALK, ~6' WIDE E17 EXISTING LIGHT POLE, TO REMAIN E18 EXISTING FINISH PRODUCT STORAGE, TO REMAIN E19 COVERED STORAGE BUILDING, TO REMAIN

ARCHITECT WILLARD E. WILLIAMS JR. **ARCHITECT**

190 North Ross Lane, Medford, Oregon Post Office Box 4460 97501

STAMP

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CCB No. 240157 Web: WWW.JBSTEELINC.COM

Medford,Oregon 97501 Office: 541.773.8325 . Fax: 541.773.6523


PACIFIC WALL SYSTEMS

TEMS

01/21/25 PROJECT NO: 2408-24 DRAWN BY: NPR CHECKED BY: WEW

SHEET TITLE: EXISTING COND. & DEMO PLAN

NOT ESTIMATING SET DESIGN DEVELOPMENT - 01

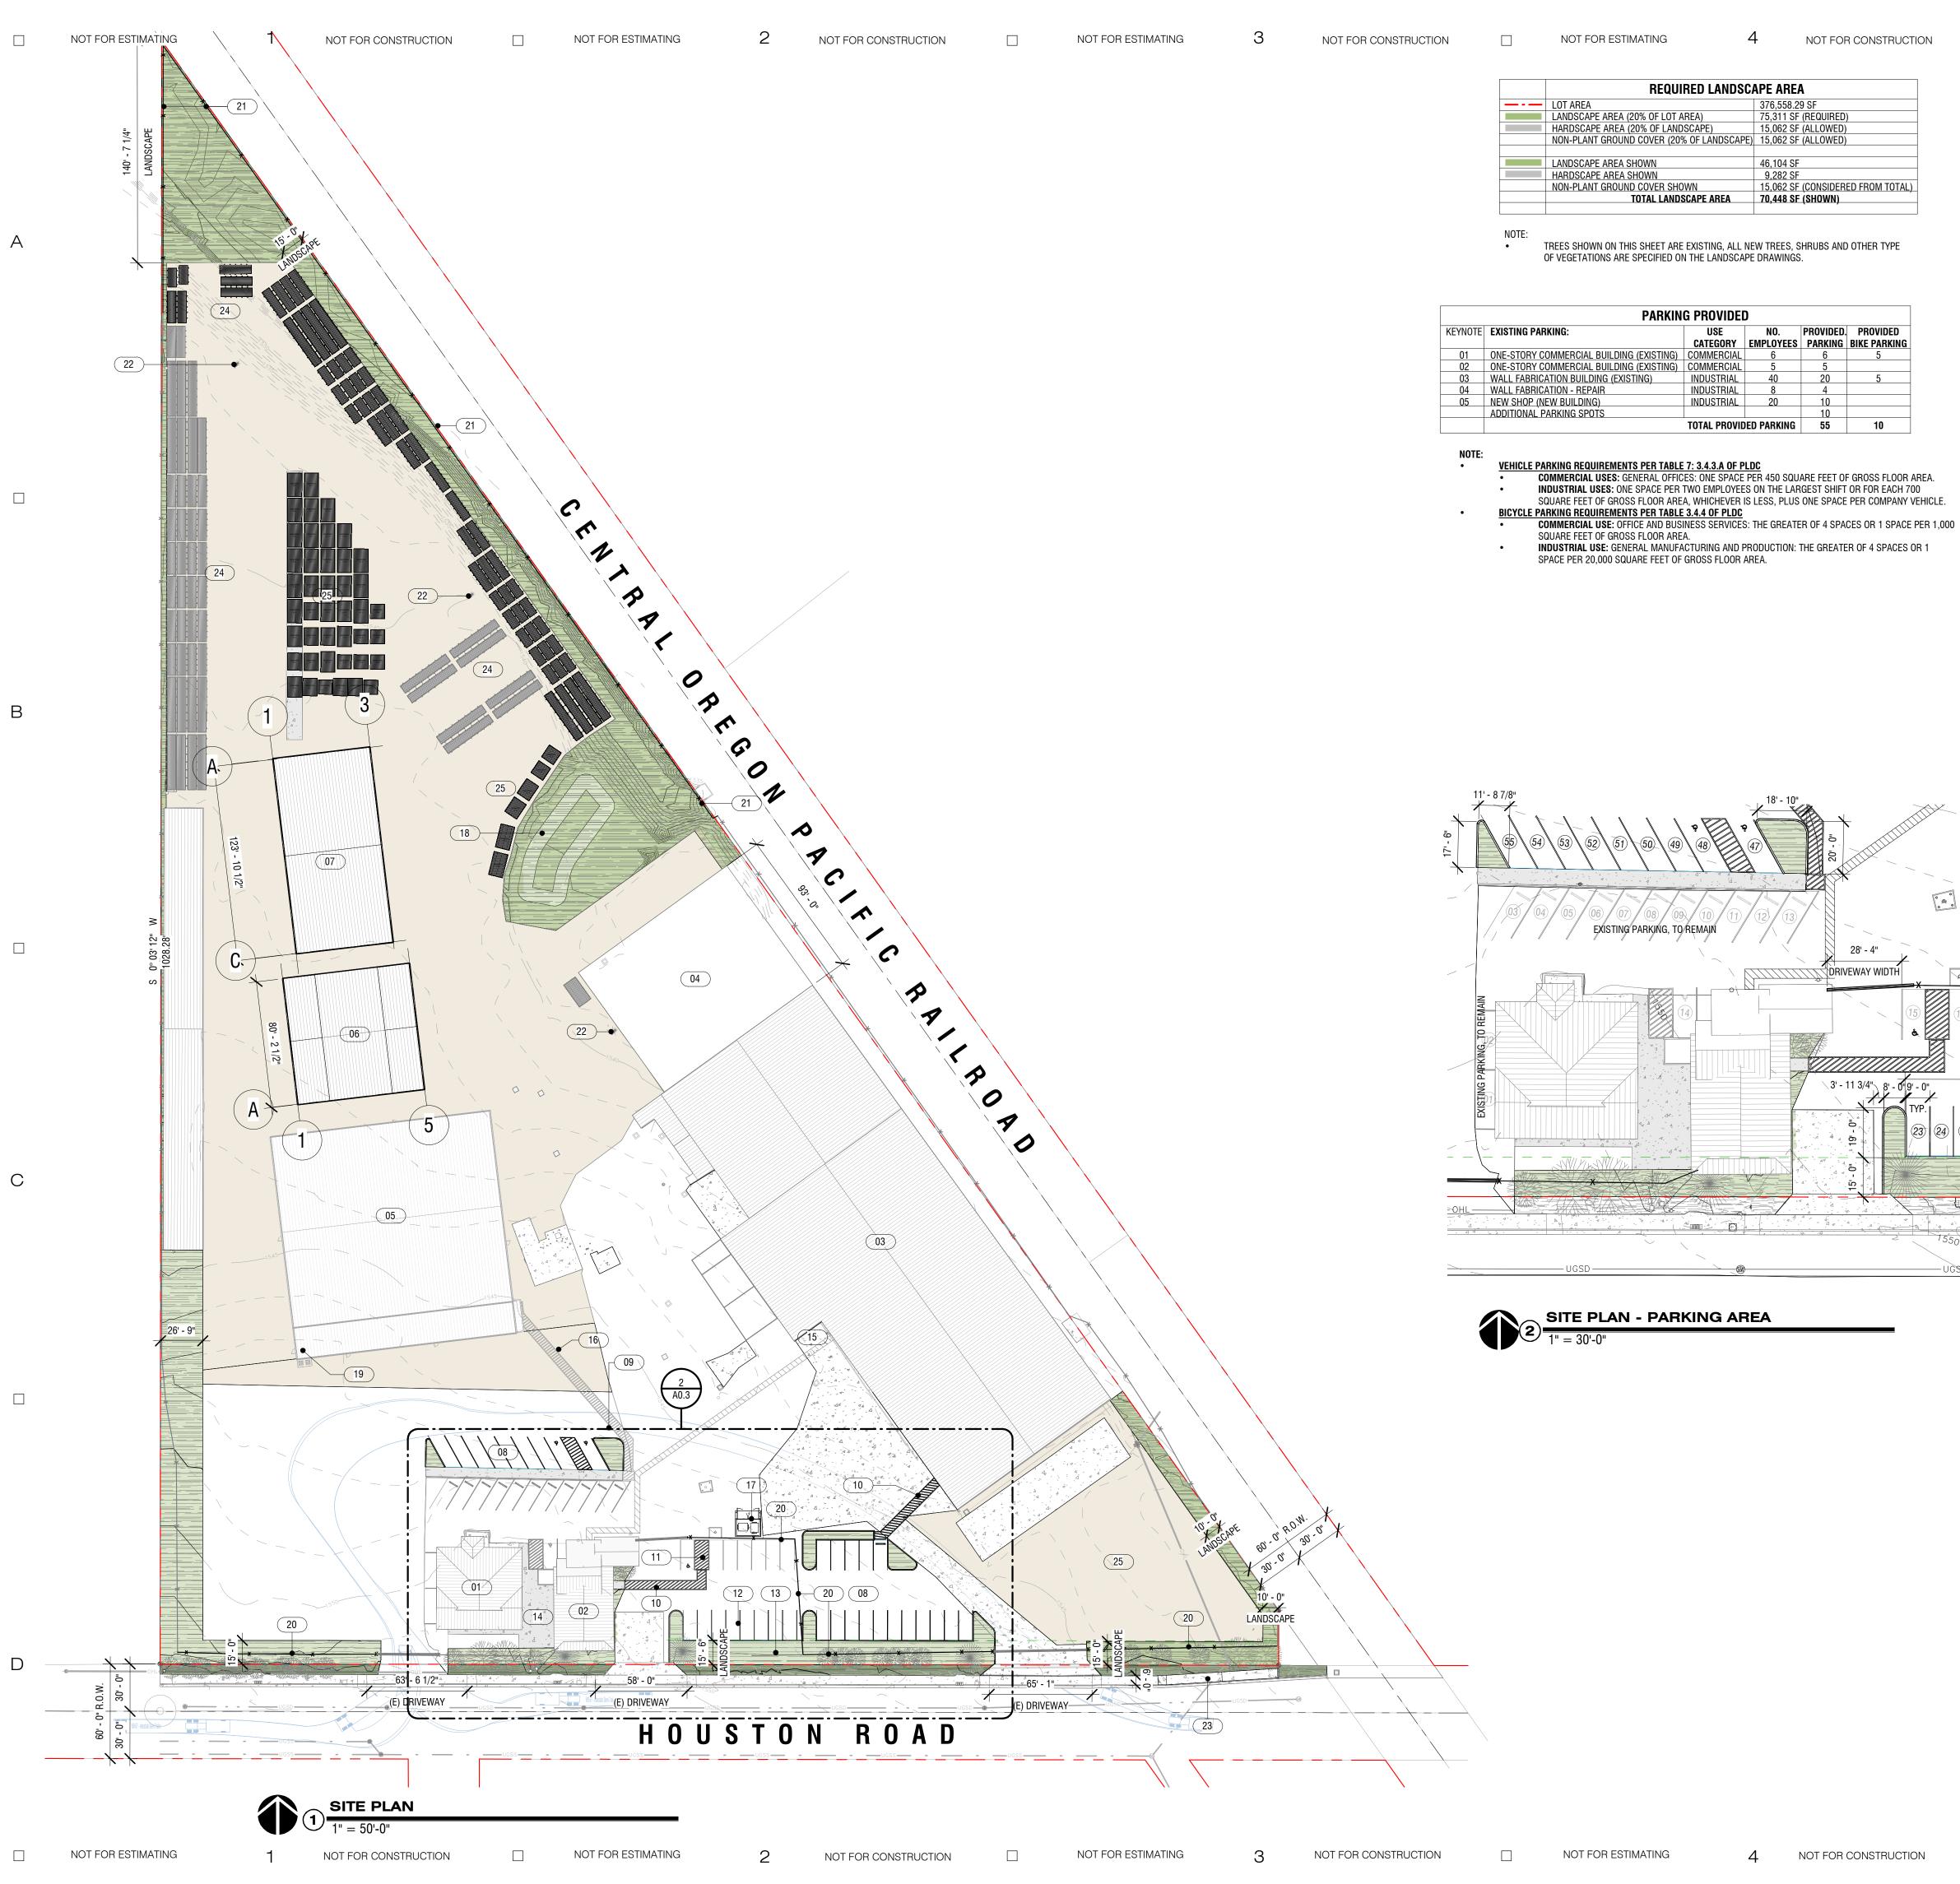

GENERAL NOTES

NOT FOR ESTIMATING

CONTRACTOR SHALL VERIFY AND CONFIRM EXISTING CONDITIONS SHOWN OR IMPLIED ON DRAWINGS PRIOR TO START OF CONSTRUCTION. NOTIFY A/E OF ANY DISCREPANCIES.

NOT FOR CONSTRUCTION

- EXISTING CONDITIONS BASED ON CIVIL DESIGN BY POWELL ENGINEERING, AND GEOTECHNICAL INVESTIGATION REPORT BY MARQUESS & ASSOCIATES, INC.
- STORM DRAIN AND WATER TREATMENT DESIGN BY CIVIL, SEE CIVIL DRAWINGS FOR ADDITIONAL
- SITE ELECTRICAL BY OTHERS. NEW AND EXISTING CONDITIONS SHOWN IN THIS PLAN ARE ASSUMED AND GENERIC IN NATURE, AND NOT IN CONTRACT (N.I.C.).
- SITE UTILITIES (WATER, SEWER, ETC.), BY OTHERS. NEW AND EXISTING CONDITIONS SHOWN IN THIS PLAN ARE ASSUMED AND GENERIC IN NATURE, AND NOT IN CONTRACT (N.I.C.)

KEYNOTE - SITE CONDITIONS KEYNOTE DESCRIPTION

01	EXISTING ONE-STORY COMMERCIAL BUILDING (2,480 SQ FT), TO REMAIN
02	EXISTING ONE-STORY COMMERCIAL BUILDING (2,379 SQ FT), TO REMAIN
03	EXISTING WALL FABRICATION BUILDING (47,275 SQ FT), TO REMAIN
04	PHASE 1 - EXTENSION TO WALL FABRICATION - REPAIR (IN SEPARATE PERMIT) (4,630 SQ FT)
05	PHASE 2 - NEW SHOP BUILDING 'B' (SQ FT TBD)
06	PHASE 1 - BUILDING 'C', EXTENSION TO EXISTING BUILDING (6,480 SQ FT TOTAL)
07	PHASE 1 - BUILDING 'D', NEW BUILDING OVER EXISTING SLAB (7,688 SQ FT)
08	NEW PARKING AREA
09	PEDESTRIAN CROSSWALK TO NEW BUILDING
10	PEDESTRIAN CROSSWALK TO EXISTING BUILDING
11	EXISTING PARKING SPOT REPLACED WITH ADA AISLE
12	IMPROVED EXISTING PARKING AREA
13	IMPROVED LANDSCAPE
14	EXISTING BICYCLE PARKING FOR COMMERCIAL AREA
15	PROPOSED BICYCLE PARKING FOR WAREHOUSE (WALL FABRICATION BUILDING) AREA
16	PROPOSED NEW BICYCLE PARKING AREA
17	PROPOSED TRASH ENCLOSURE LOCATION, SEE DETAIL 9/A0.4
18	PROPOSED BIOSWALE LOCATION
19	PROPOSED EXTERIOR HVAC EQUIPMENT LOCATION, SCREENED BY CHAIN LINK FENCE, SEE DETAIL 14/A0.4
20	EXISTING FENCE TO BE IMPROVED, SIGHT OBSCURING SLATS TO BE ADDED TO FENCE ALONG HOUSTON RD.
21	RELOCATED 6' HIGH CHAIN LINK FENCE
22	EXISTING LIGHT POLE, TO REMAIN

23 NEW SIDEWALK, 6' WIDE, VERIFY LENGTH

EXTERIOR RAW MATERIAL STORAGE

EXISTING PARKING, TO REMAIN

EXTERIOR FINISHED PRODUCT STORAGE

ARCHITECT

WILLARD E. WILLIAMS JR.

ARCHITECT

190 North Ross Lane, Medford, Oregon Post Office Box 4460 97501

Member American Institute Of Architects

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Medford,Oregon 97501 Office: 541.773.8325 . Fax: 541.773.6523 CCB No. 240157

Web: WWW.JBSTEELINC.COM

PACIFIC WALL SYSTEMS

01/21/25


PROJECT NO: 2408-24 DRAWN BY: NPR CHECKED BY: WEW

SHEET TITLE: SITE PLAN

NOT ESTIMATING SET DESIGN DEVELOPMENT - 01

NOT FOR ESTIMATING

NOT FOR CONSTRUCTION

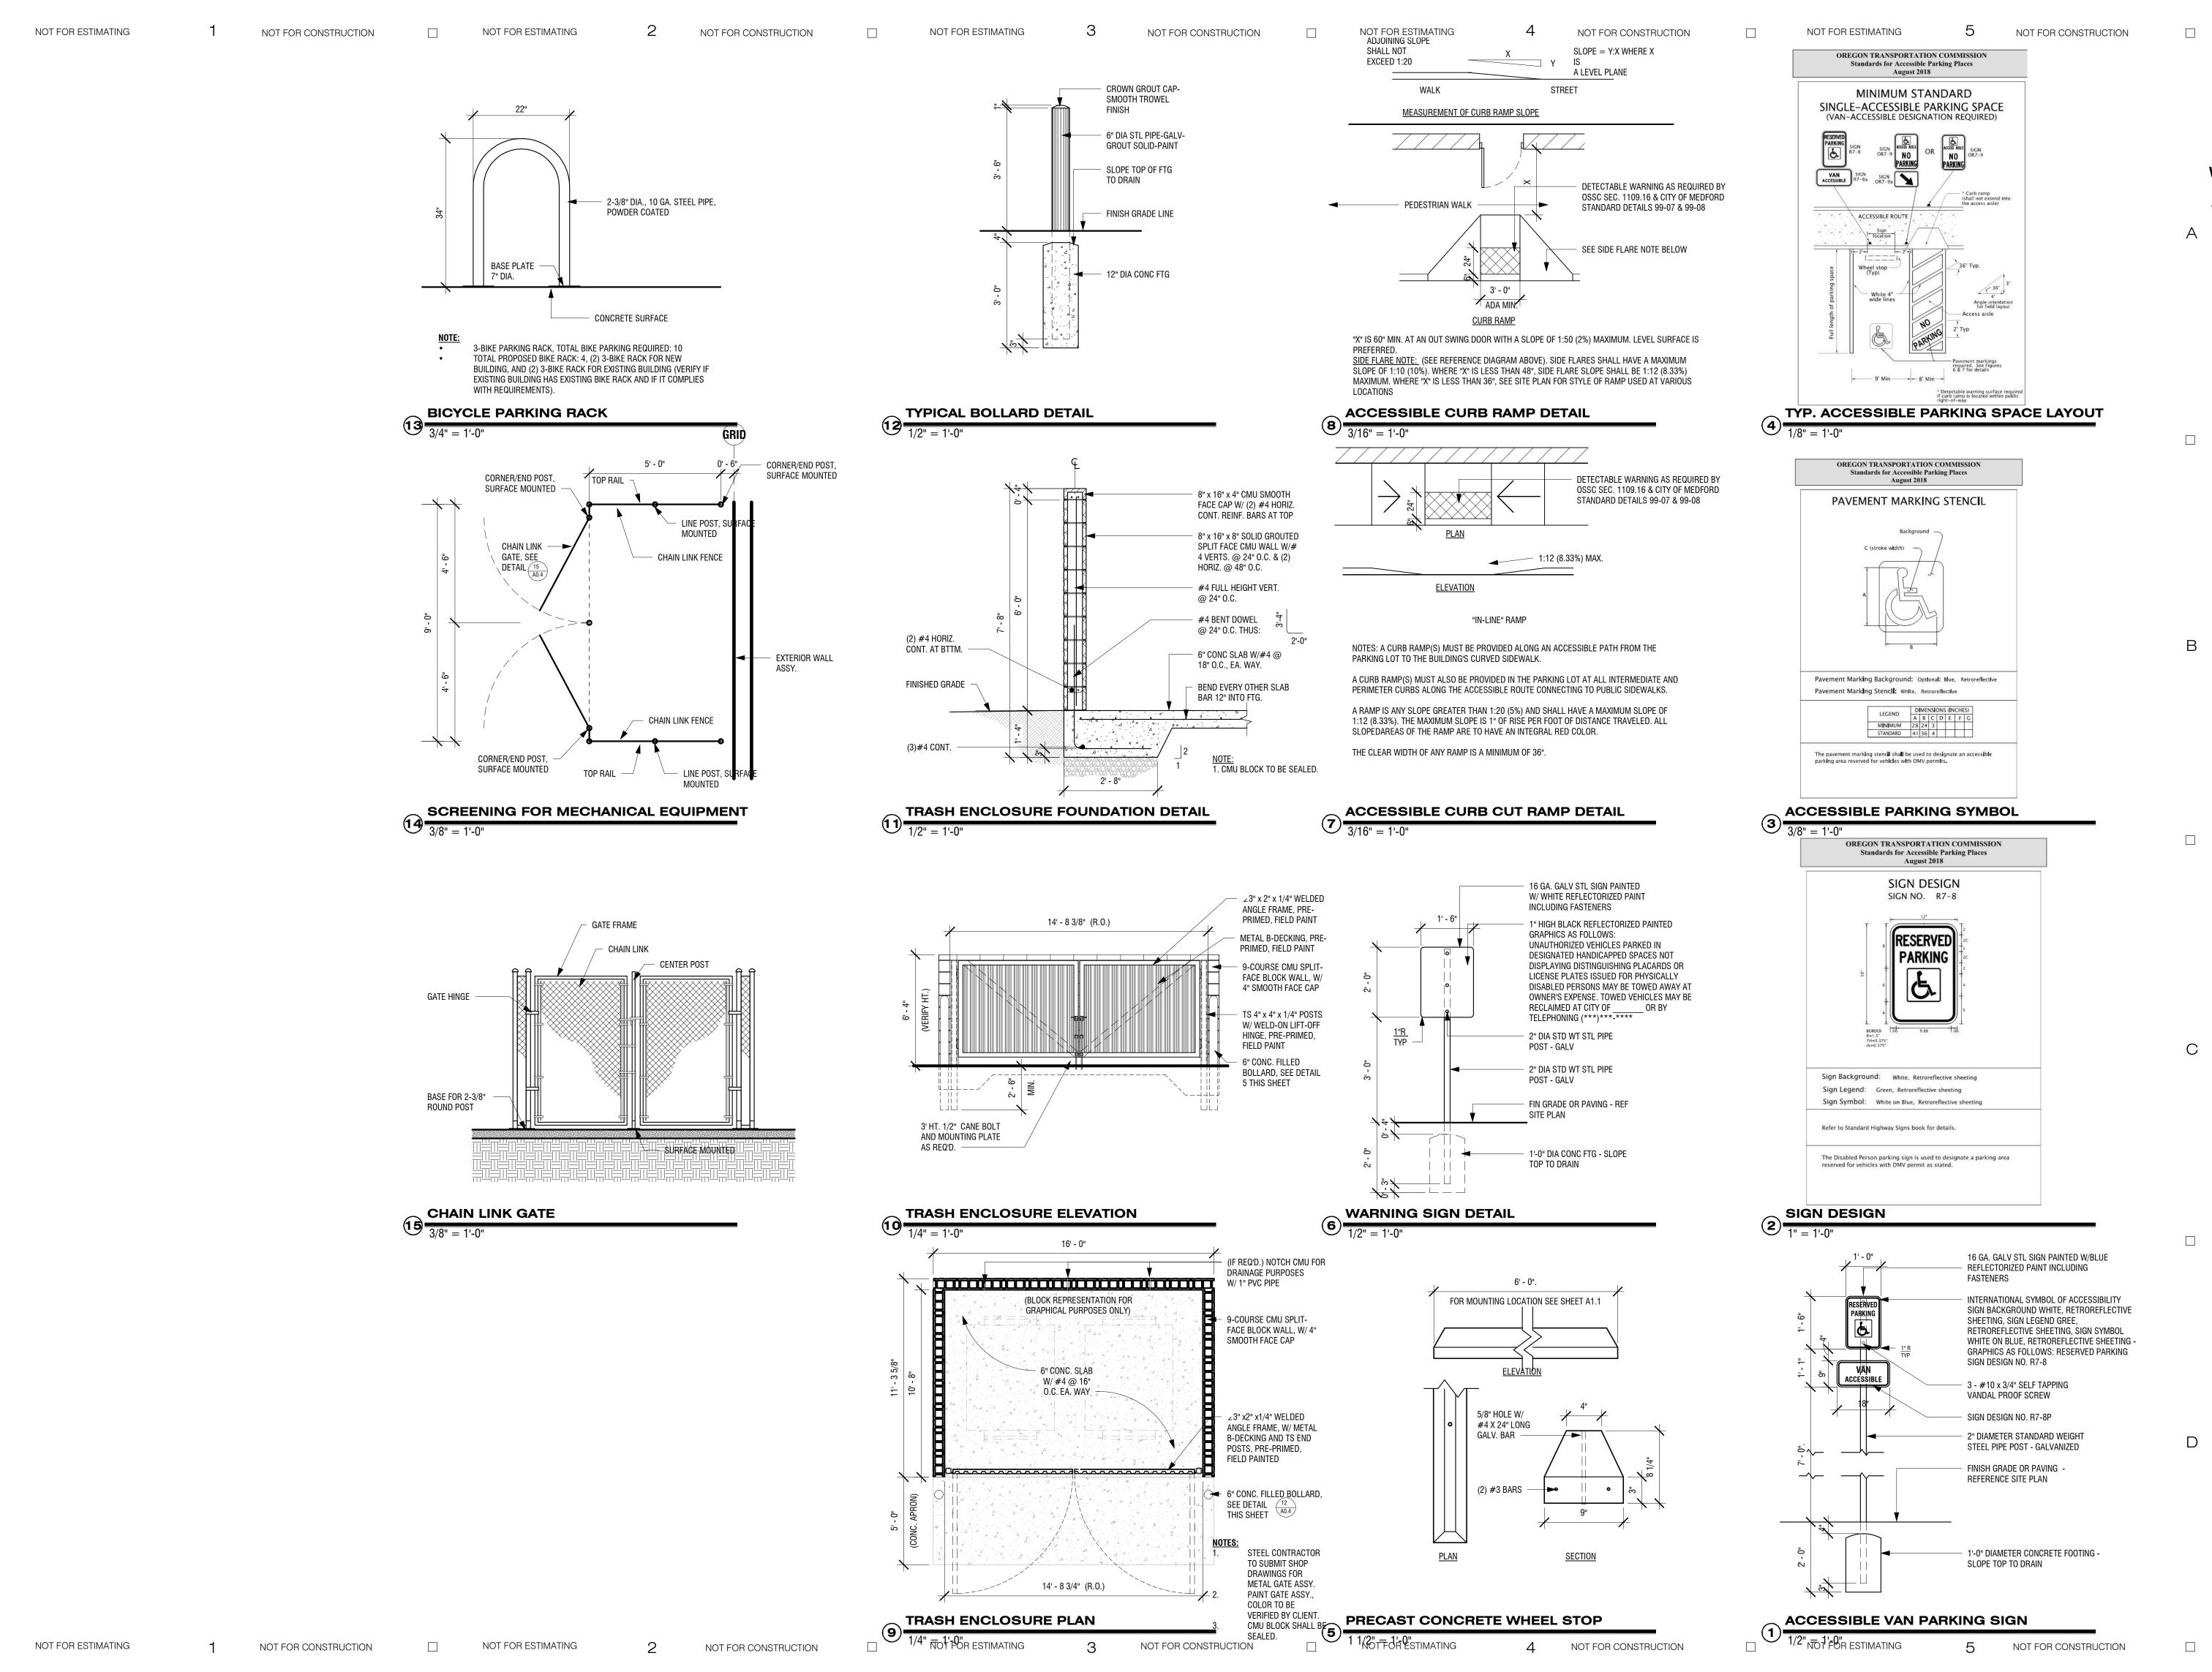

ARCHITECT WILLARD E. WILLIAMS JR. 190 North Ross Lane, Medford, Oregon

Medford,Oregon 97501

Office: 541.773.8325 . Fax: 541.773.6523

Web: WWW.JBSTEELINC.COM

PACIFIC WALL SYSTEMS

CCB No. 240157

Post Office Box 4460 97501 Member American Institute Of Architects STAMP

NOT ESTIMATING SET

DESIGN DEVELOPMENT - 01

Description

01/21/25


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CHECKED BY: WEW

SHEET TITLE:

Date



NOT FOR ESTIMATING
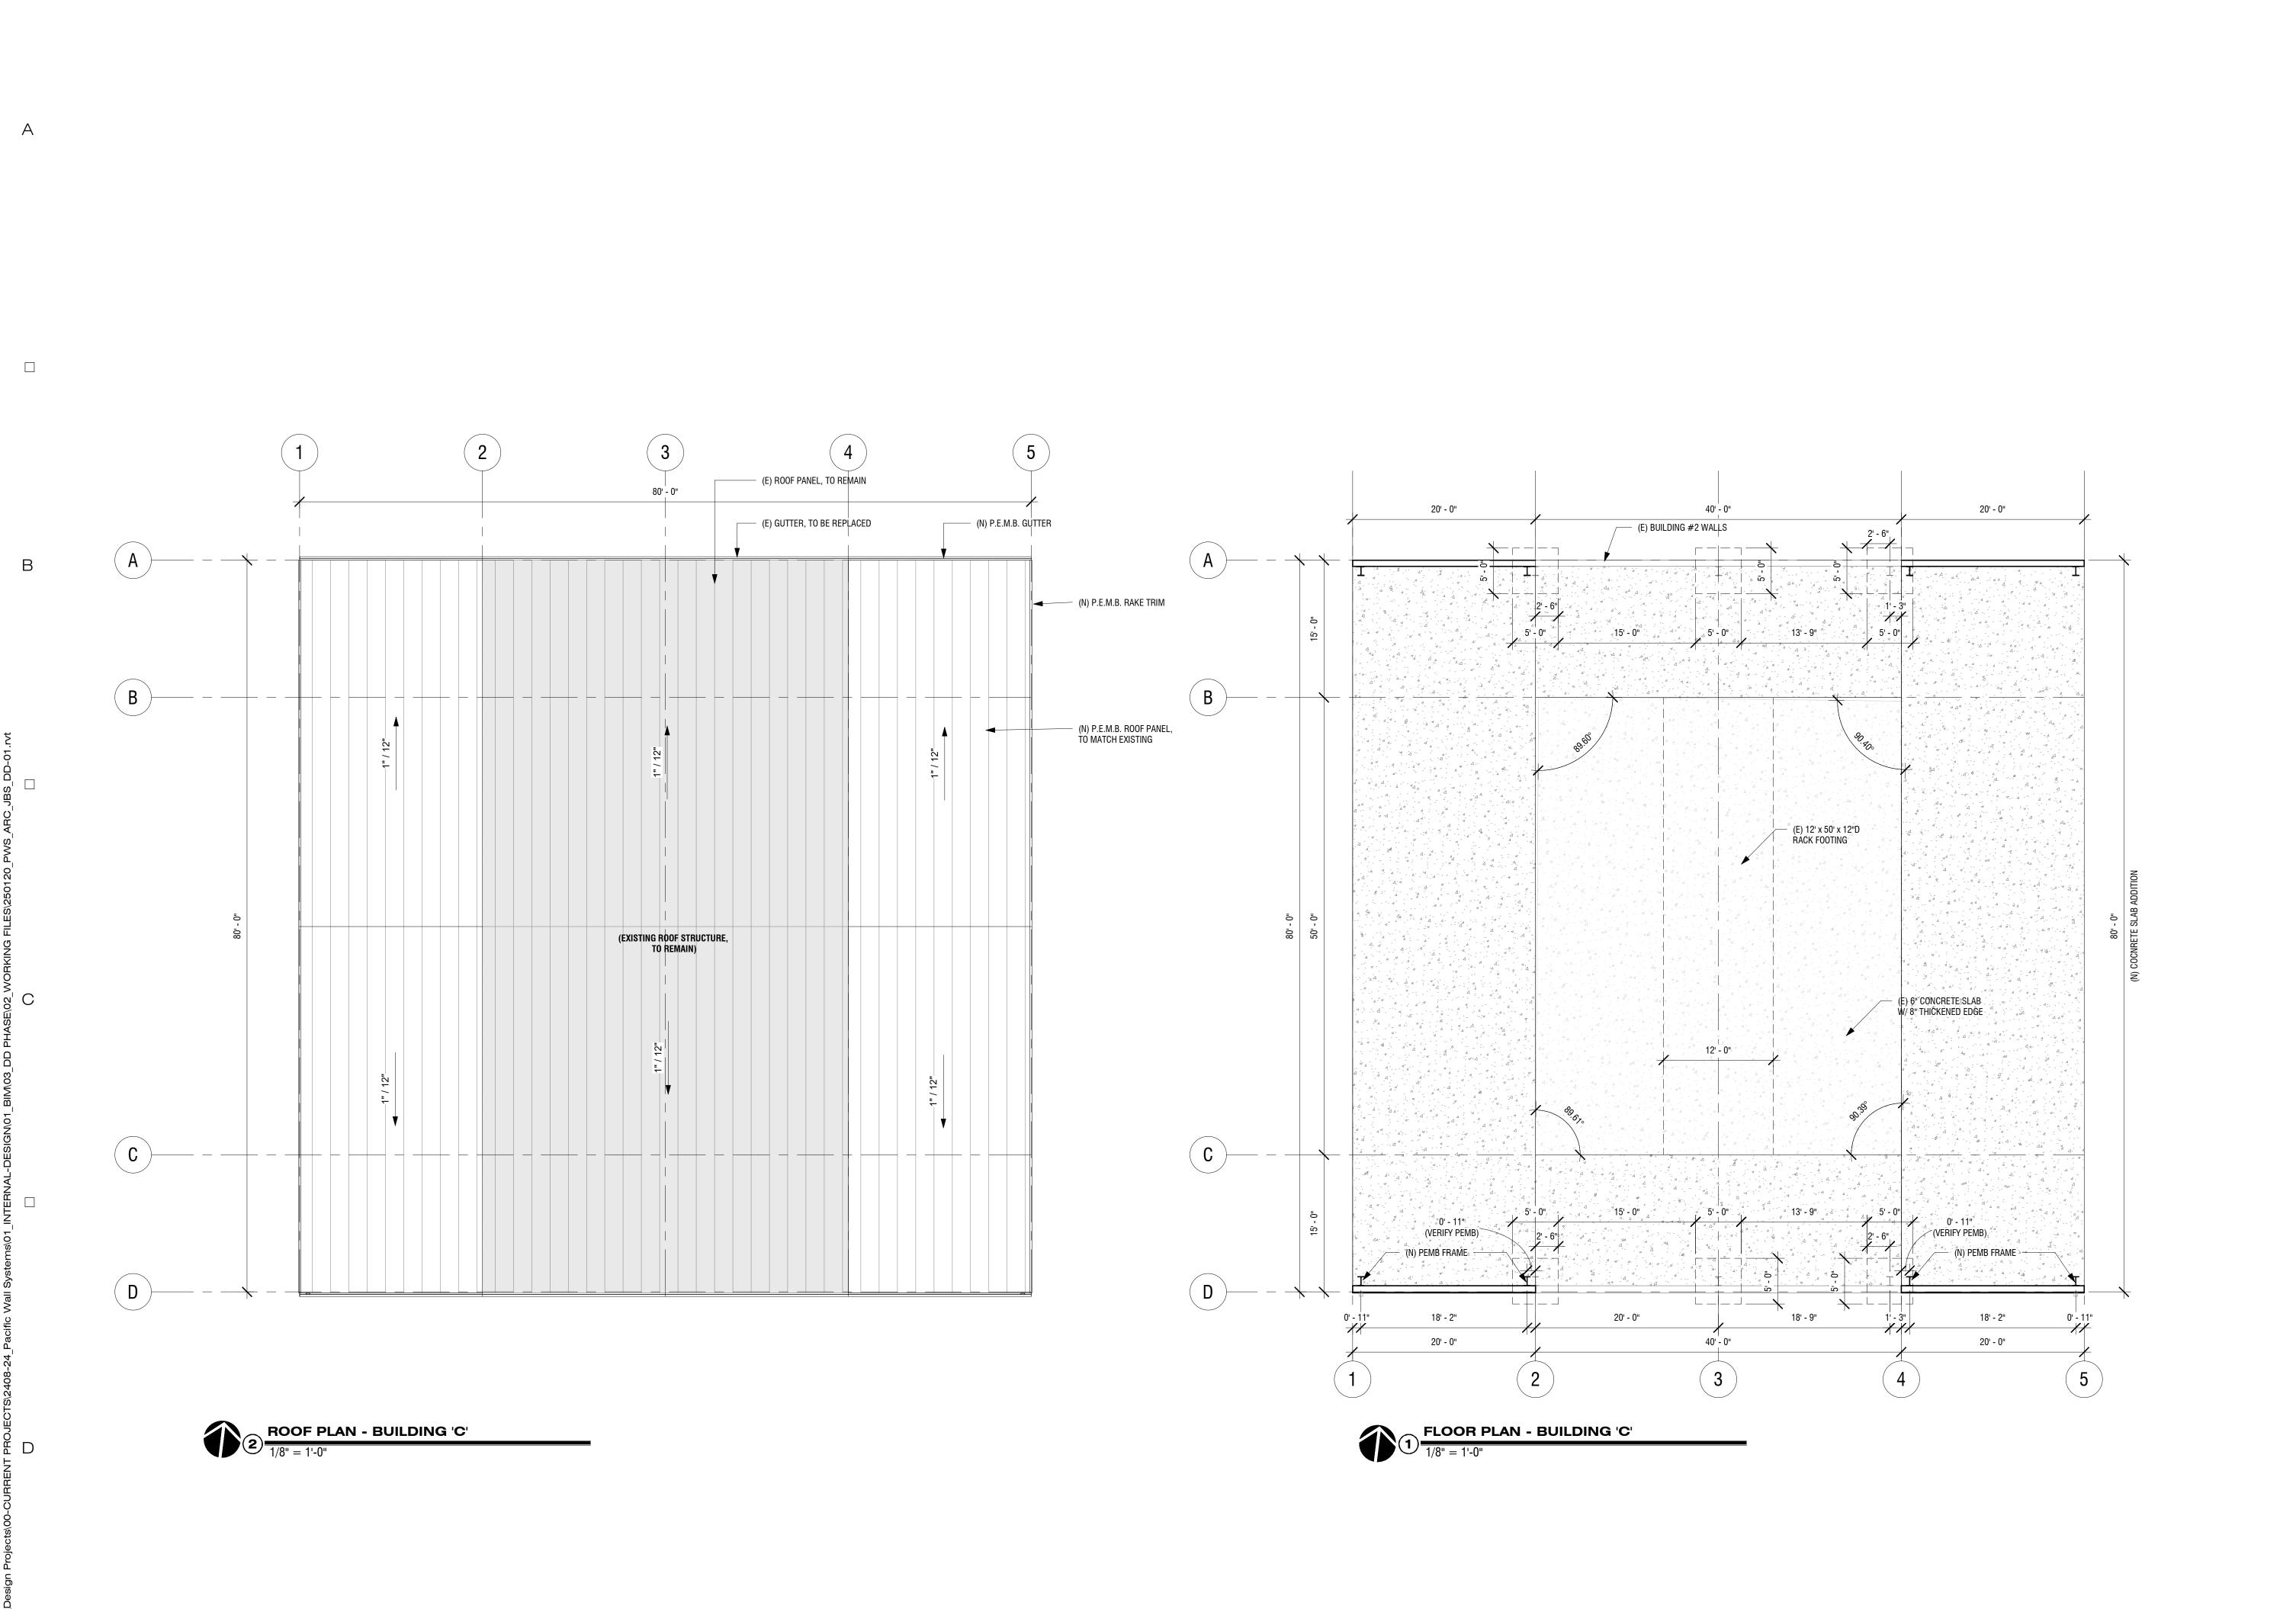
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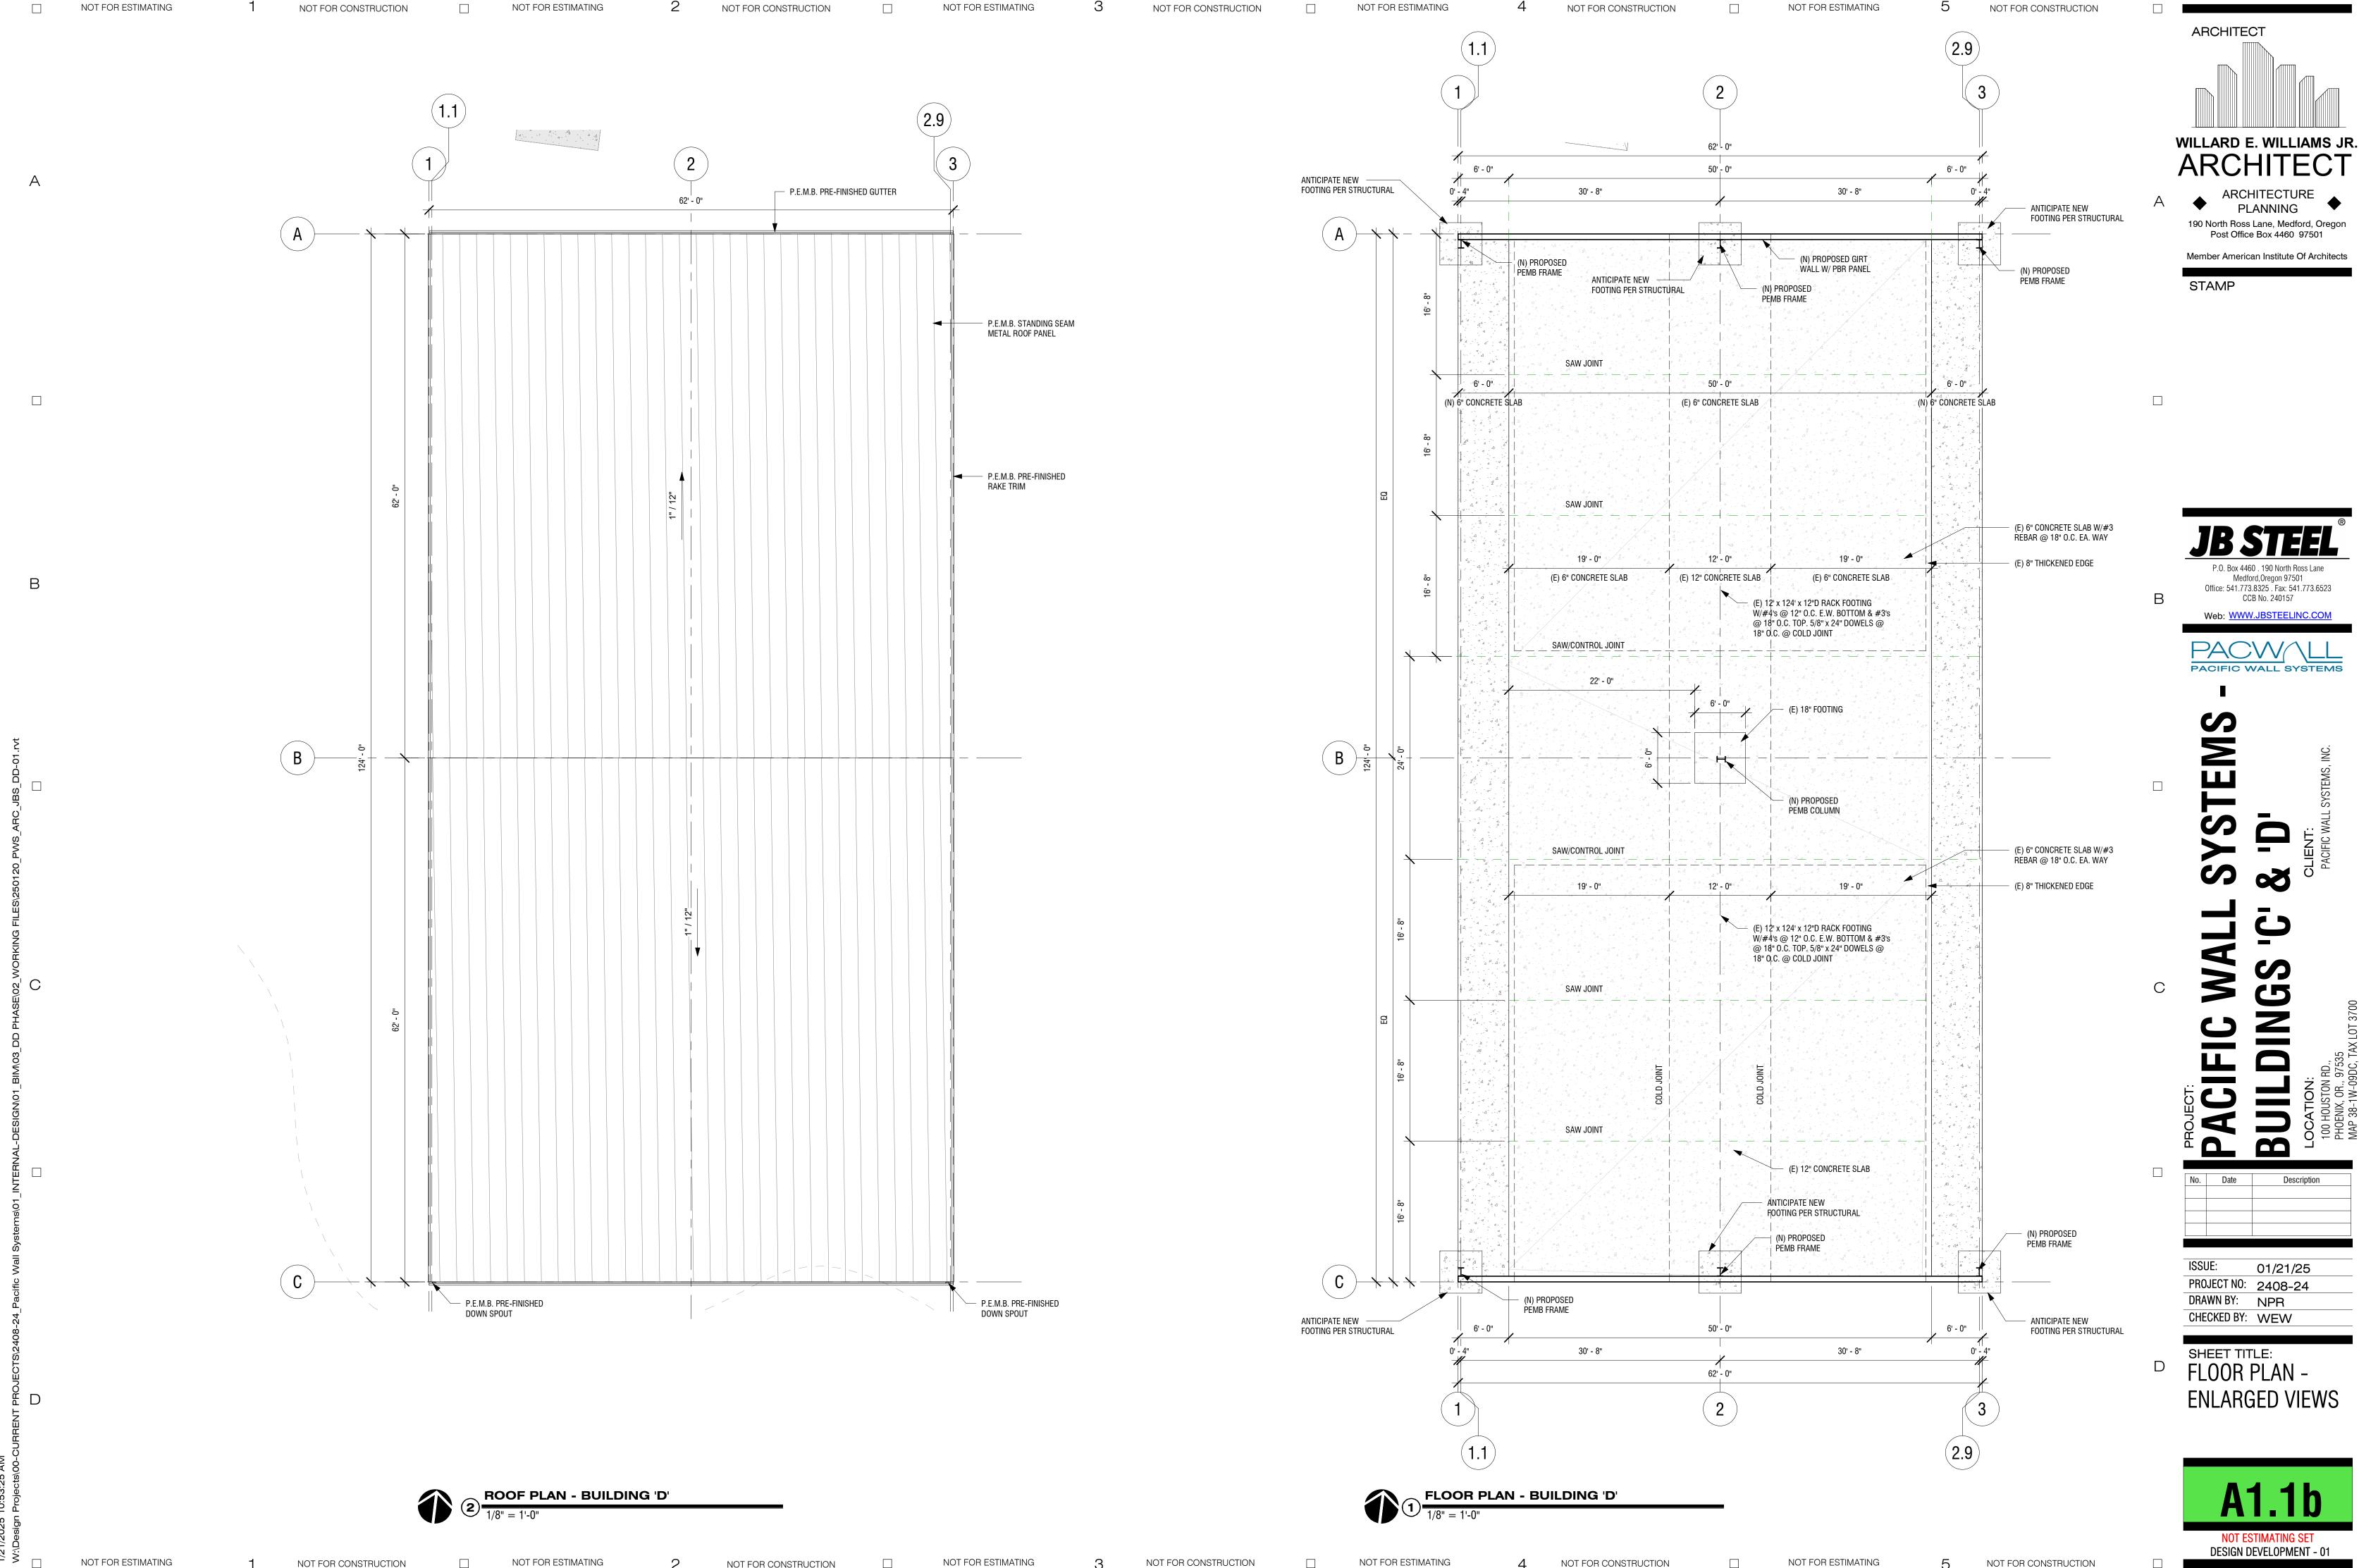
ARCHITECT WILLARD E. WILLIAMS JR. ARCHITECT 190 North Ross Lane, Medford, Oregon Post Office Box 4460 97501 Member American Institute Of Architects STAMP

P.O. Box 4460 . 190 North Ross Lane Medford,Oregon 97501 Office: 541.773.8325 . Fax: 541.773.6523 CCB No. 240157 Web: WWW.JBSTEELINC.COM PACIFIC WALL SYSTEMS

01/21/25 PROJECT NO: 2408-24 DRAWN BY: NPR CHECKED BY: WEW

SHEET TITLE:
FLOOR PLAN -**ENLARGED VIEWS**

NOT ESTIMATING SET DESIGN DEVELOPMENT - 01



NOT FOR ESTIMATING


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NOT FOR CONSTRUCTION




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POWELL engineering + consulting

100 E. Main St., Suite O Medford, OR 97501541.613.0723 phone

www.powellengineeringconsulting.com

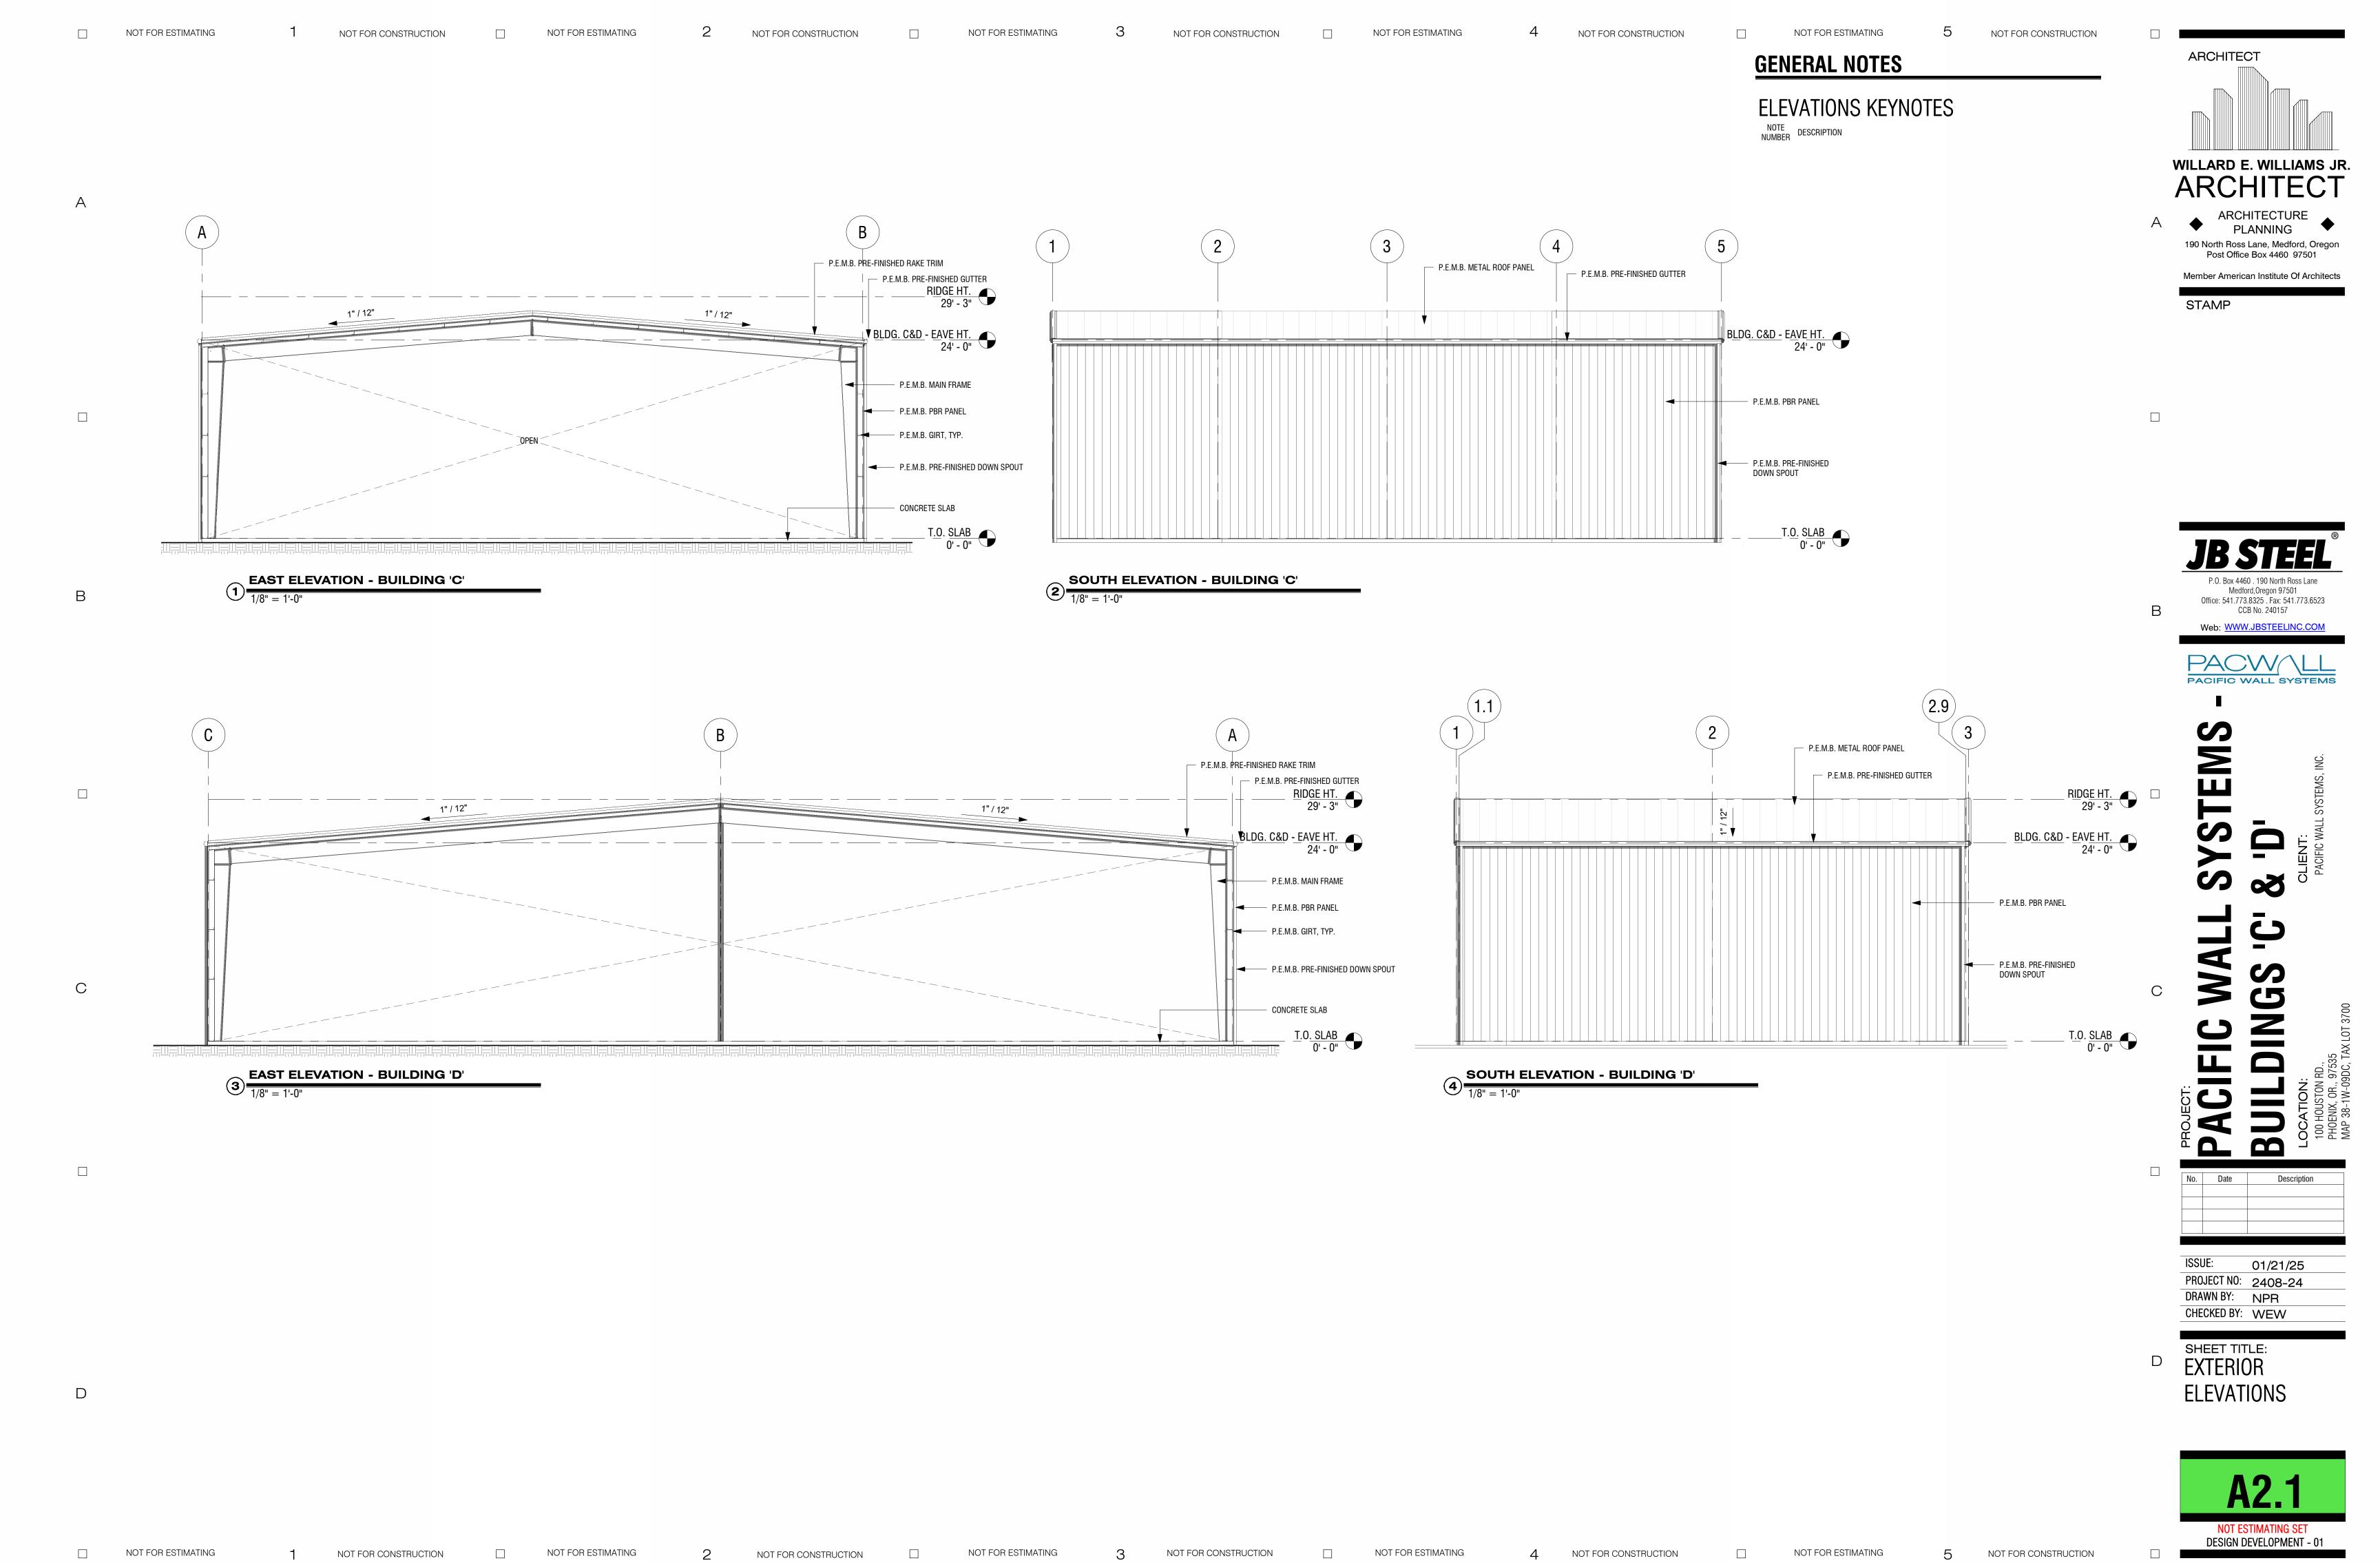

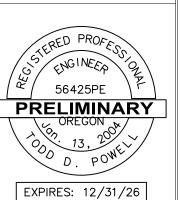VERIFY SCALES

ORIGINAL DRAWING
BAR IS ONE INCH

IF NOT ONE INCH ON THIS
SHEET, ADJUST SCALES

ALL STSTEIN;

CIVIL ENGINE

CIF

DRAWN BY: TDP

DESIGNED BY: TDP

CHECKED BY: TDP


ISSUE DATE: 01/20/25

LAND USE SET

JOB NO.

ROUGH GRADING
& DEMO PHASE

C.2 1

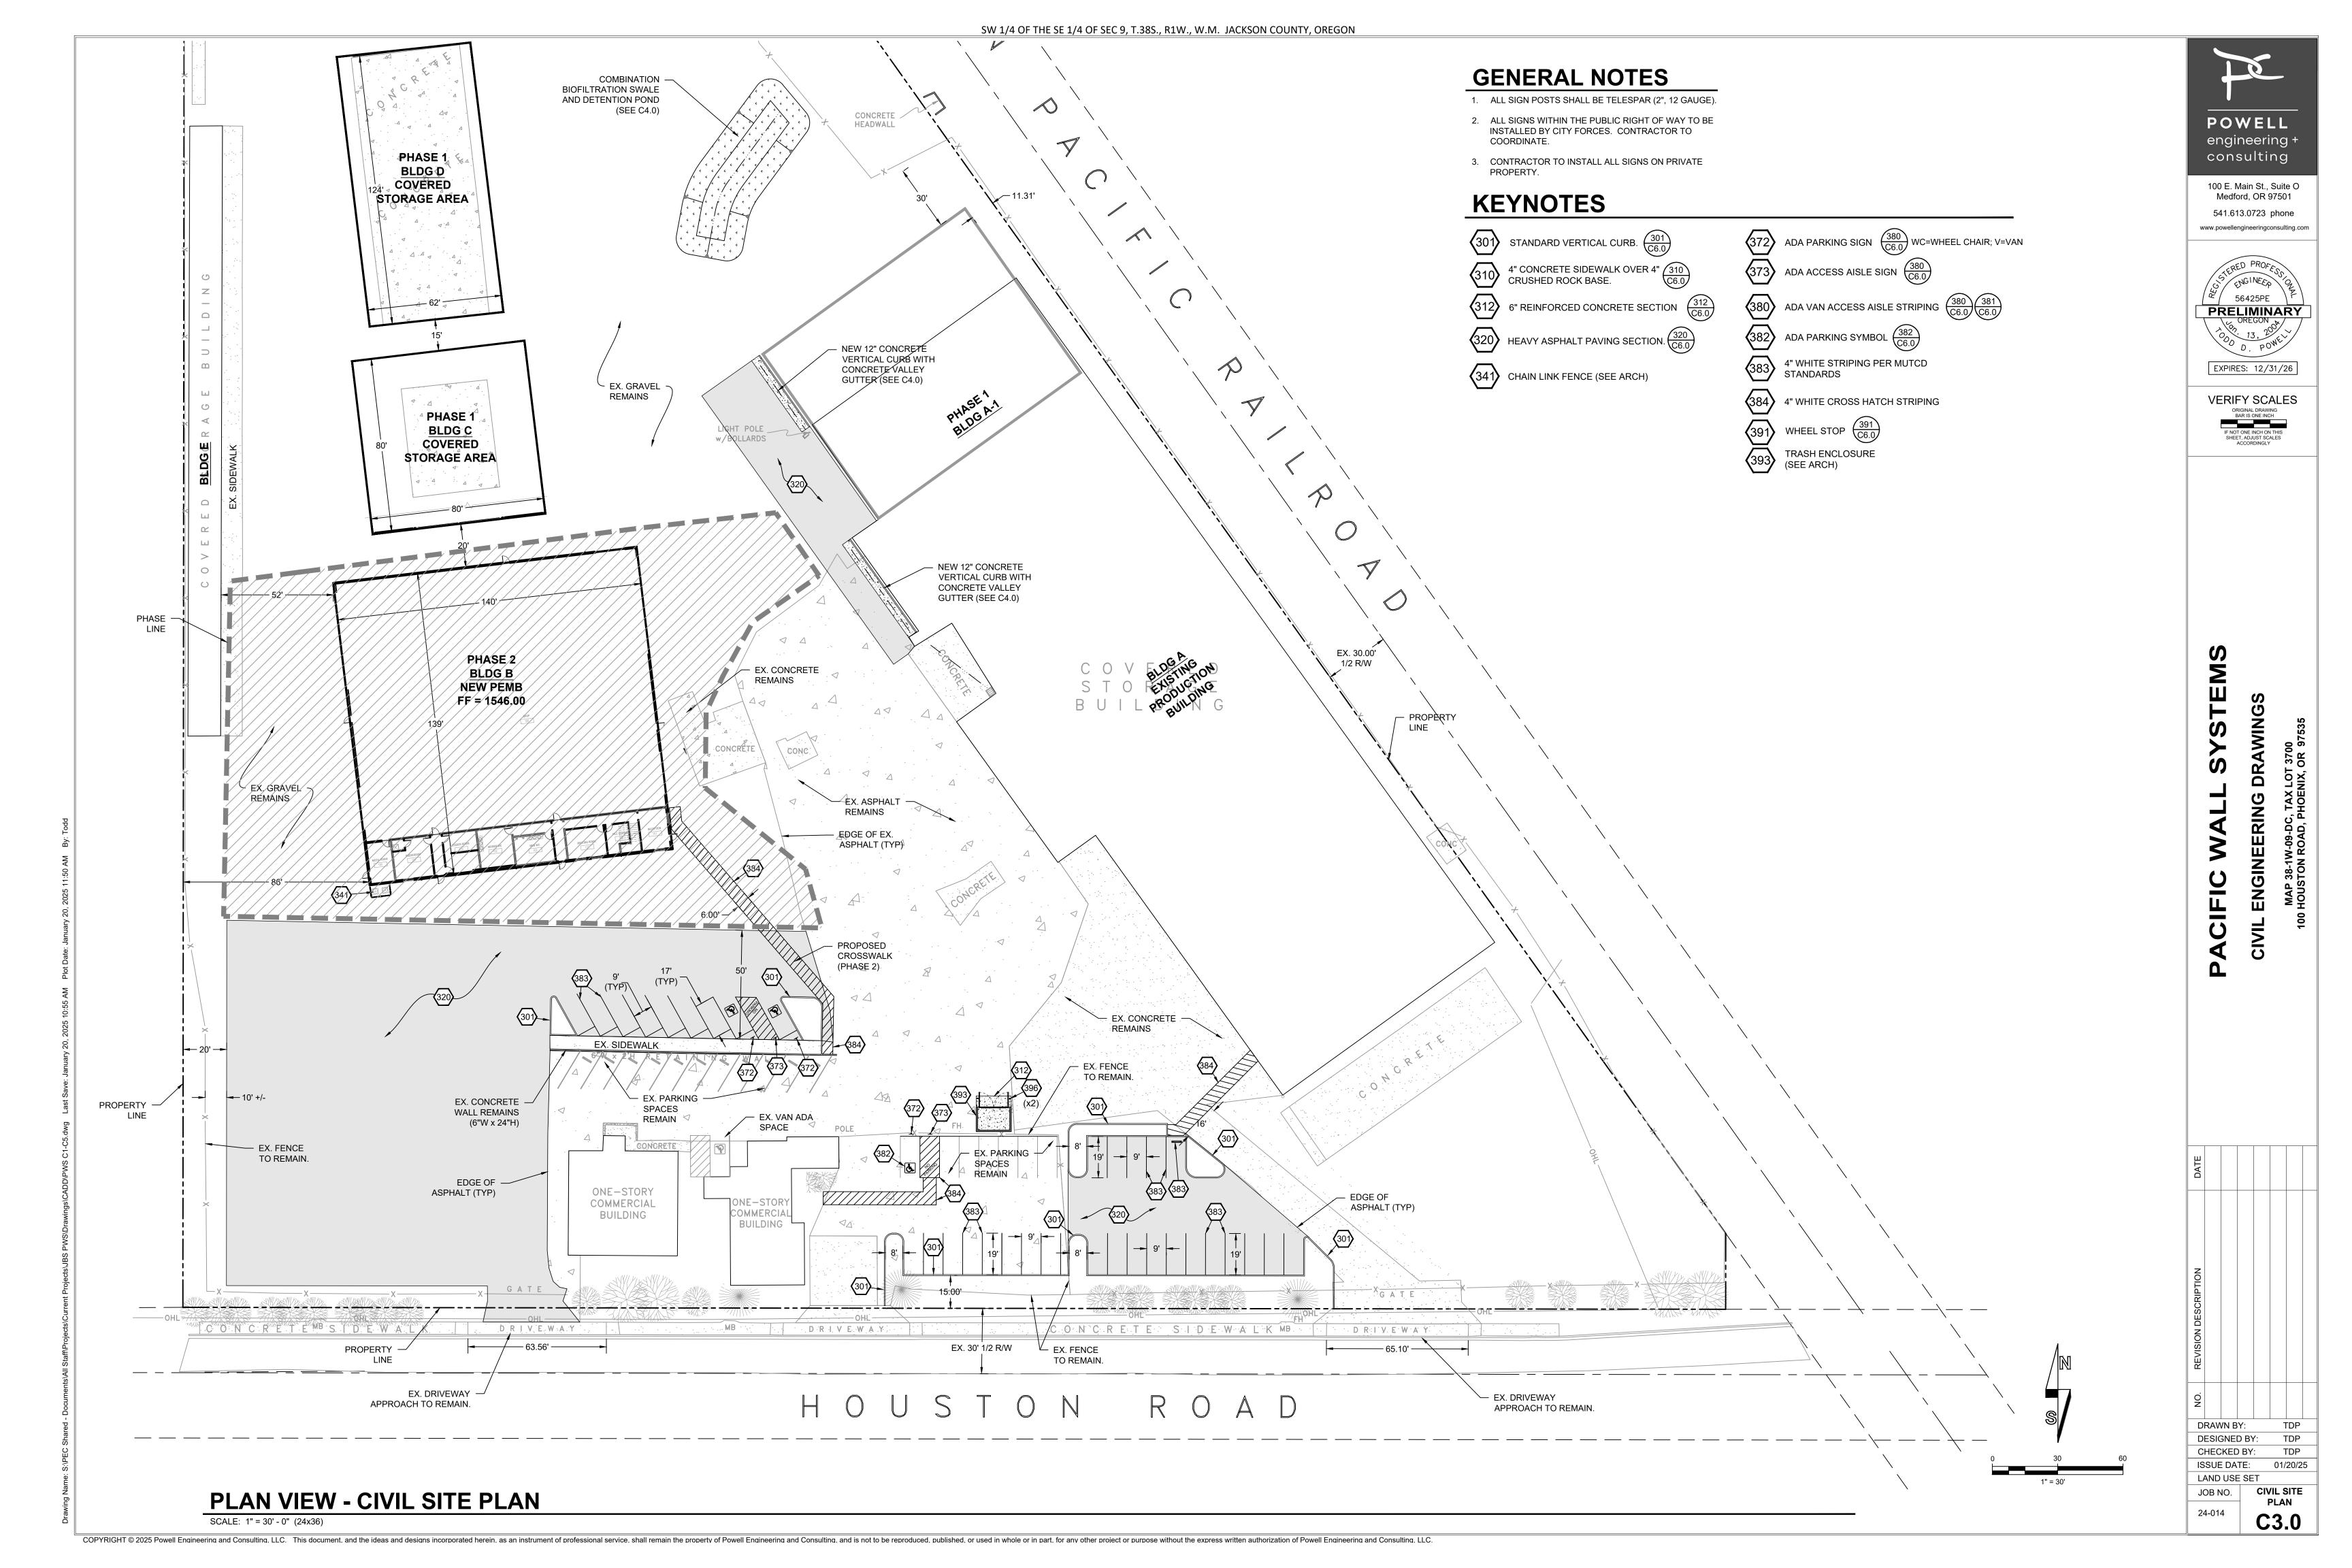

CENTRAL OREGON PACIFIC RAILROAD SITE PHOTOMETRIC PLAN

HOUSTON ROAD

OWNERSHIP OF DOCUMENTS
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RAMSAY ELECTRIC

P.O. BOX 5148
Central Point, OR 97502
(541) 772-1398
shane@ramsayelectric.com
OR CCb#34490 Lic #15-143-C

SUPERVISOR #47605:

PACIFIC WALL SYSTEM
100 HOUSTON ROAD
PHOENIX, OREGON

DRAWN BY: S.R.

JOB NO.:

SCALE: NTS
DATE 1/27/25

DATE 1/27/25

REVISIONS

BY

IEET

E.1

NOT FOR ESTIMATING

LEGEND

BUILDING SECTION SECTION I.D.

—SHEET NUMBER —DETAIL NUMBER

ENLARGED AREAS

-DETAIL NUMBER

NOTATION
INDICATOR

G = GENERAL
D = DEMOLITION
R = REMODEL

PARTITION INDICATOR

SEE SCHEDULE

SCHEDULE INDICATOR W = WINDOWS L = LOUVERS P = PANELS

INDICATES EXISTING DOOR SWING

Door And/Or Frame

CASED OPENING

ELEVATION VIEW

EARTH UNDISTURBED

CONCRETE

CONCRETE

MASONRY UNITS

CERAMIC TILE

WINDOWS OR RELITES

Door Number Denotes New Work To Existing

NOTE: THESE EXAMPLES

AND MAY OR MAY NOT

BE USED IN THIS SET

BATT INSULATION


GYPSUM BOARD

ARE GENERIC IN NATURE

SECTION VIEW

NOT FOR CONSTRUCTION

NOT FOR ESTIMATING

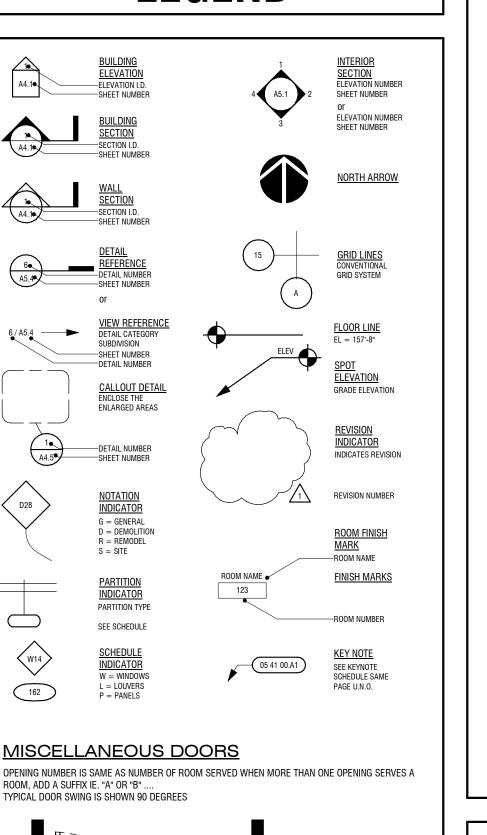

NOT FOR CONSTRUCTION

PARTIALLY CONSTRUCTED VIEW

PROJECT TEAM

PROPERTY OWNER: **PURSUIT PROPERTIES, LLC** CONTACT: JEFF NORMAN ADDRESS: P.O. BOX 4417 PHONE: 541-200-9682 **WILLARD WILLIAMS**

ADDRESS: P.O. BOX 4460, MEDFORD, OREGON 97501 PHONE: 541-773-8325 FAX: 541-773-6523 EMAIL: willardw@jbsteelconstruction.com

JB STEEL, INC. ADDRESS: 190 NORTH ROSS LANE, MEDFORD, OREGON 97501 PHONE: 541-773-8325 FAX: 541-773-6523 CCB #240157

POWELL ENGINEERING + CONSULTING CONTACT: TODD POWELL ADDRESS: 100 E. MAIN ST., SUITE O, MEDFORD, OR., 97501 PHONE: 541-613-0723 EMAIL: todd@powellengineeringconsulting.com

STRUCTURAL ENGINEER: ADDRESS: PHONE: EMAIL:

GENERAL CONTRACTOR:

PLUMBING CONTRACTOR CONTACT: ADDRESS: PHONE: **ELECTRICAL CONTRACTOR:** RAMSAY ELECTRIC CONTACT: SHANE RAMSAY

MECHANICAL CONTRACTOR:

CONTACT:

ADDRESS:

CONTACT:

EMAIL:

NOT FOR ESTIMATING

ADDRESS: P.O. BOX 5148, CENTRAL POINT, OR., 97502 PHONE: 541-772-1398 EMAIL: shane@ramsayelectric.com FIRE SPRINKLER CONTRACTOR:

ADDRESS: PHONE: LANDSCAPE CONTRACTOR: FIGUEROA'S LANDSCAPING & CONSTRUCTION, LLC. CONTACT: ADRIANA FIGUEROA

ADDRESS: P.O. BOX 4709, MEDFORD, OR., 97501

<u>PLANS ON SITE</u> [OSSC 107.3.1] ONE SET OF THE APPROVED PLANS BEARING THE STAMP OF THE LOCAL BUILDING DIVISION MUST BE MAINTAINED ON THE PROJECT SITE THROUGHOUT ALL PHASES OF CONSTRUCTION AND MUST BE MADE AVAILABLE TO BUILDING AND FIRE INSPECTORS FOR REFERENCE DURING INSPECTION.

PHONE: 541-621-8970

EMAIL: figuland@hotmail.com

Know what's **below. Call** before you dig. 800-332-2344

VICINITY & LOCATION MAP



BUILDING CODE SUMMARY

NOT FOR ESTIMATING

PROJECT DESCRIPTION:

PROJECT CONSISTS ON THE EXTENSION OF AN EXISTING PRE-ENGINEERED METAL BUILDING, WHICH WE WILL DEFINE AS BUILDING

100 HOUSTON RD., PHOENIX, OR., 97535 38-1W-09DC, LOT 3700 **MAP NUMBER & LOT**

CITY OF PHOENIX, OREGON **GOVERNING AUTHORITY**

PHOENIX MUNICIPAL CODE (PMC) LOCAL: BUILDING 2022 OREGON STRUCTURAL SPECIALTY CODE (OSSC) **PLUMBING** 2023 OREGON PLUMBING SPECIALTY CODE (OPSC) MECHANICAL 2022 OREGON MECHANICAL SPECIALTY CODE (OMSC) ELECTRICAL 2023 OREGON ELECTRICAL SPECIALTY CODE (OESC) **ENERGY EFFICIENCY** 2021 OREGON ZERO ENERGY READY COMMERCIAL CODE (OZERCC) ADA ACCESSIBILITY: 2017 ACCESSIBLE AND USABLE BUILDING AND FACILITIES, ICCA117.1 FIRE SAFETY: 2022 OREGON FIRE CODE (OFC) CONSTRUCTION TYPE: (G-I) GENERAL INDUSTRIAL ZONING CLASSIFICATION: SITE AREA: LOT COVERAGE 4% (PHASE 1 - NEW BUILDINGS)

13% (47,400SF)

17.500 SF

(NOT) REQUIRED

PERVIOUS COVERAGE IMPERVIOUS COVERAGE BUILDING AREAS: BUILDING 'C' ADDITION 3,200 SF BUILDING 'C' EXISTING BUILDING 'D' NEW S-1 (MODERATE-HAZARD STORAGE)

OCCUPANCY GROUP: OCCUPANCY SEPARATION: SPRINKLERS: ALLOWABLE AREA: AREA MODIFICATIONS BASIC ALLOWABLE:

LANDSCAPE COVERAGE

STRUCTURAL DESIGN CRITERIA: LOCATION: PHOENIX, OREGON SEISMIC CATEGORY WIND EXPOSURE: 96 MPH - EXPOSURE "C" LIVE LOAD: FORCES RESISTING SYSTEM: STRUCTURAL STEEL MOMENT FRAMES & CROSS BRACING

OCCUPANT LOAD TYPE: OCCUPANT LOAD FACTOR: GROUP S-1 STORAGE: OCCUPANT LOAD: MIXED OCCUPANCY: ACCESSORY USE: XITS REQUIRED: REQUIRED EXIT WIDTH: MAXIMUM TRAVEL DISTANCE:

EXITING REQUIREMENTS

1/500 SF GROSS - T-1004.1.1 14,168/500 SF GROSS = 28 OCCUPANTS

2 (TABLE 1019.2) 32" (OSSC. SEC. 1008.1) 200' (TABLE 1016.1) CORRIDOR RATING: 1 HOUR (TABLE 1017.1)

PARKING REQUIREMENTS:

VEHICLE PARKING REQUIREMENTS PER TABLE 7: 3.4.3.A OF PLDC COMMERCIAL USES: GENERAL OFFICES: ONE SPACE PER 450 SQUARE FEET OF GROSS FLOOR AREA. INDUSTRIAL USES: ONE SPACE PER TWO EMPLOYEES ON THE LARGEST SHIFT OR FOR EACH 700 SQUARE FEET OF GROSS FLOOR AREA, WHICHEVER IS LESS, PLUS ONE SPACE PER COMPANY VEHICLE.

BICYCLE PARKING REQUIREMENTS PER TABLE 3.4.4 OF PLDC COMMERCIAL USE: OFFICE AND BUSINESS SERVICES: THE GREATER OF 4 SPACES OR 1 SPACE PER 1,000 SQUARE FEET OF GROSS FLOOR AREA. INDUSTRIAL USE: GENERAL MANUFACTURING AND PRODUCTION: THE GREATER OF 4 SPACES OR 1 SPACE PER 20,000 SQUARE FEET OF GROSS FLOOR AREA.

MODERATE HAZARD STORAGE GROUP S-1 OSSC. SEC. 311.2

NOT FOR CONSTRUCTION

EXTENSION OF EXISTING BUILDING 'C' & NEW STORAGE BUILDING 'D'

ADDRESS: 100 HOUSTON RD, PHOENIX, OR., 97535 MAP NUMBER: 38-1W-09DC, LOT 3700

PACIFIC WALL SYSTEMS

DRAWING INDEX

SHEET	SHEET NAME	REV	DATE
GENERAL			
	OOVED OUTET		
G0.0	COVER SHEET		
CIVIL			
C2.1	ROUGH GRADING & DEMO PHASE		
C3.0	CIVIL SITE PLAN		
C4.0	DRAINAGE PLAN		
C5.0	SITE UTILITY PLAN		
ARCHITECTURAL			
A0.2	EXISTING COND. & DEMO PLAN		
A0.3	SITE PLAN		
A0.4	TYP. SITE DETAILS		
A1.1a	FLOOR PLAN - ENLARGED VIEWS		
A1.1b	FLOOR PLAN - ENLARGED VIEWS		
A2.1	EXTERIOR ELEVATIONS		
ANDSCAPE			
L1	LANDSCAPE PLAN		

ARCHITECT WILLARD E. WILLIAMS JR ARCHITECT

190 North Ross Lane, Medford, Oregon Post Office Box 4460 97501

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JB STEEL

Office: 541.773.8325 . Fax: 541.773.6523

PACIFIC WALL SYSTEMS

TEMS

01/21/25 PROJECT NO: 2408-24 DRAWN BY: NPR CHECKED BY: GRC

SHEET TITLE:

NOT ESTIMATING SET

NOT FOR CONSTRUCTION

NOT FOR ESTIMATING

DESIGN DEVELOPMENT - 01

NOT FOR ESTIMATING

NOT FOR CONSTRUCTION

NOT FOR ESTIMATING

NOT FOR CONSTRUCTION

NOT FOR ESTIMATING

NOT FOR CONSTRUCTION

NOT FOR CONSTRUCTION


COORDINATION WITH THE EXCAVATING AND SITE CONTRACTOR IS IMPERATIVE.


- 1. ALL PLANTING BEDS TO BE EXCAVATED TO DEPTH OF 12" AS DETERMINED BY THE SURROUNDING Concrete and hardscapes. This may require adding or subtracting viable Native Soil to ACHEVE CONSISTENT SUBGRADE FOR THE SUBSEQUENT TOP SOIL FILL AS NOTED BELOW. (SEE DETAIL.) VIABLE NATIVE SOIL DOES NOT INCLUDE CONCRETE, ROCK GREATER THAN 11/2" DIAMETER, STRICTLY CLAY SOIL, OR NON-NATIVE DEBRIS. SITE CONTRACTOR RESPONSIBLE FOR CREATING CONSISTENT SUB-BASE OF NATIVE SOIL REQUIRED FOR THE SPECIFIED 12" OF NET TOP SOIL FILL ADDING OR SUBTRACTING NATIVE MATERIALS AS REQUIRED.
- 2. FILL PLATERS WITH LOCALLY SOURCED SCREENED TOP SOIL THAT HAS BEEN TESTED AND SHOWN TO PROVIDE FOR SUPERIOR PLANT GROWTH WITH TESTING AT APPROVED SOIL TESTING COMPANY. PLACE SOIL IN LIFTS OF NO MORE THAN 6" AT A TIME AND COMPACT ENTIRE SURFACE WITH A WATER FILLED ROLLER BEFORE PLACING SUBSEQUENT LIFTS.
- 3. PLACEMENT OF ANY SOIL TO BE DONE IN CON=ORDINATION WITH SUITABLE WEATHER CONDITIONS SO AS TO PREVENT DAMAGE TO SOIL STRUCTURE FROM EXCESSES OF MOISTURE.
- 4. Sub-grading and final grade to consist of a smooth even grade, no undulation greater THEN PLUS OR MINUS 1" WITHIN ANY 10 LINEAL FEET OF DISTANCE.
- 5. ALL SUB-GRADES TO BE ADEQUATELY FIRM WITHOUT BEING OVERLY COMPACTED.
- 6. Once top soil has been placed the Landscape Contractor is to add mature compost at a rate of 3 cu. yds. per 1,000 sq ft. and then rip to blend with top soil to a depth of 8". PRE-BLENDED SOIL MEETING THESE REQUIREMENTS IS ACCEPTABLE.
- 7. Finish grade in shrub areas to be a smooth even grade mounded 3" high in the middle OF BEDS AND ENDING 3" BELOW SURROUNDING AREAS. ALL FINISH GRADING TO PROMOTE POSITIVE DRAINAGE AWAY FROM STRUCTURES AND TO BE DONE IN SUCH A WAY AS TO ELIMINATE PUDDLING OF COLLECTION OF WATER.
- 8. Landscape Contractor is responsible for addressing any drainage problems encountered DURING THE COURSE OF THE CONSTRUCTION, WITH SITE CONTRACTOR.
- 9. SEE DETAIL FOR PROFILE.


IRRIGATION DETAILS


I. AN AUTOMATIC IRRIGATION SYSTEM TO BE PROVIDED FOR ALL PLANT MATERIALS AREAS IN ACCORDANCE WITH INDUSTRY STANDARDS. SYSTEM IS INTENDED TO PERFORM AT 15 GPM AND 50 PSI. CONFIRM ON-SITE BEFORE PROCEEDING DEPENDING ON THE AVAILABLE WATER SOURCE. A) IRRIGATION SYSTEM TO BE ISOLATED FROM POTABLE WATER BY AN APPROVED BACKFLOW DEVICE INSTALLED TO LOCAL AND STATE STANDARDS.


- 2. ALL MATERIALS ARE TO BE NEW AND IN ORIGINAL CONDITION.
- 3. NO ZONE SHALL EXCEED 15 GPM. PIPE SIZED TO HAVE LESS THAN 5 FT / SEC FLOWS.
- 4. PLACE MANUAL DRAIN VALVES AS NEEDED AT LOW POINTS IN MAINLINE
- 5. MAINLINE SHOULD BE LOCATED IN AREA WITH LEAST CONFLICT WITH SURROUNDING UTILITIES.
- 6. HUNTER PROS-C SERIES FOR A DRIP ZONE IRRIGATION. ADD NEW IRRIGATION TO EXISTING CONTROLLER.
- 7. ALL DRIP ZONES TO USE PVC LATERALS TO LOCATE A POINT OF CONNECTION IN EACH INDIVIDUAL PLANTING BED.
- 8. SHRUB AREAS TO BE IRRIGATED BY DRIP IRRIGATION AND LAWN & SWALE TO USE MP-2000 OR MP-1000 ROTOR NOZZLE
- A. ALL SURFACE DRIP TUBING TO BE 1/2" POLY TUBING. TUBING ENDS TO HAVE REMOVABLE CAPS.
- B. TUBING TO BURIED A MINIMUM OF 3-5" AND HELD DOWN EVERY 5' WITH J-STAKES. C. ALL DRIP ZONES TO INCLUDE A 200 MESH FILTER AND 30PSI PRESSURE REGULATOR
- 9. ALL TRENCHING TO BE A MINIMUM OF 15" DEEP. BACKFILL IS TO BE CLEAN AND FREE OF
- ANY MATERIAL LARGER THAN I 1/2" IN DIAMETER. BACKFILL SHALL BE ADEQUATELY COMPACTED AND GUARANTEED AGAINST FURTHER SETTLING.
- 10. CONTROL WIRES ARE TO BE A MINIMUM OF 14GA AND SPLICED WITH WATER PROOFCONNECTIONS ONLY.
- PLACE ALL WIRING BELOW PIPING IN TRENCHES.
- II. SLEEVING TO BE PROVIDED UNDER ALL HARDSCAPES BY GENERAL CONTRACTOR FOR
- IRRIGATION PURPOSES
- 12. IRRIGATION SYSTEM TO BE GUARANTEED AGAINST DEFECTIVE MATERIAL OR WORKMANSHIP FOR ONE YEAR FROM THE DATE OF FINAL ACCEPTANCE. DAMAGE OR LOSS DUE TO VANDALISM, FREEZING OR ACTS OF NEGLECT BY OTHERS, IS EXEMPT FROM CONTRACTOR'S
- REPLACEMENT RESPONSIBILITY. 13. PROVIDE OWNER WITH AN ACCURATE AS-BUILT LOCATING ALL VALVES, WIRE SPLICES, MAIN
- LINE AND ANY SLEEVING. 14. PROVIDE OWNER WITH PRELIMINARY WATERING SCHEDULE FOR THE ESTABLISHED LANDSCAPE.
- 15. PROVIDE OWNER WITH COMPLETE SET OF WRITTEN INSTRUCTIONS FOR OPERATION OF
- SPRINKLER SYSTEM INCLUDING SPRING START UP, CLOCK OPERATION, AND WINTERIZATION.
- 16. WALK OWNER THROUGH THE ENTIRE SYSTEM DESCRIBING THE OPERATING INSTRUCTIONS.
- 17. IRRIGATION TO BE DESIGED ON SITE, BY A LICENSED LANDSCAPE CONTRACTOR.

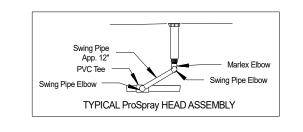


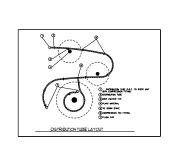


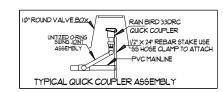


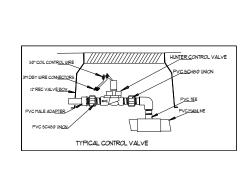

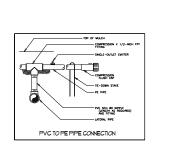

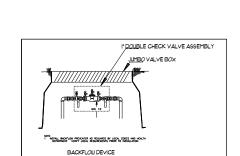

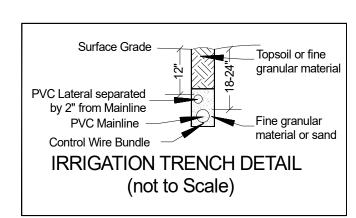


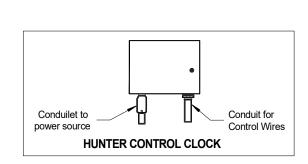





EXISTING TREES AND SHRUBS TO REMAIN HOUSTONROAD

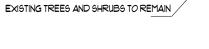

SITE PLAN - TRUE NORTH



GENERAL CONSTRUCTION NOTES

- 1. GENERAL PREPARATION OF SITE TO INCLUDE: A. ERADICATION OF WEEDS THROUGH THE CERTIFIEDAPPLICATION OF HERBICIDES, ALLOWING ADEQUATE TIME FOR KILL.
- B. REMOVAL, FROM SITE, OF ALL EXISTING SURFACE ROCK AND/OR DEBRIS IN PLANTING BEDS. 2. ALL SHRUB BEDS TO BE FINISH RAKED TO A SMOOTH CONDITION PRIOR TO MULCHING.
- 3. Medium dark multi-bark to be placed in all shrub beds to a depth of 3" 4. MAINTENANCE UP TO DATE DAY OFACCEPTANCE. INCLUDING BUT NOT LIMITED TO: A. Maintain planting areas in a healthy, weedfree condition through a minimum
- OF BI-WEEKLY VISITS. B. REPLACE ANY MATERIAL SHOWING SIGNS OF STRESS.
- C. MONITOR IRRIGATION FOR CORRECT TIMING.

REQUIRED LANDSCAPE AREA

REES SHOWN ON THIS SHEET ARE EXISTING, ALL NEW TREES, SHRUBS AND OTHER TYPE

ADDITIONAL GRADING INFORMATION IS AVAILABLE ON ATTACHED GVIL DRAWINGS

NON-PLANT GROUND COVER (20% OF LANDSCAPE) 15,062 SF (ALLOWED)

TOTAL LANDSCAPE AREA

OF VEGETATIONS ARE SPECIFIED ON THE LANDSCAPE DRAWINGS.

15,062 SF (ALLOWED)

10,798 SF (CONSIDERED FROM TOTAL)

9,282 SF

75,311 SF (SHOWN)

LOT AREA

HARDSCAPE AREA (20% OF LANDSCAPE)

LANDSCAPE AREA SHOWN

HARDSCAPE AREA SHOWN

NON-PLANT GROUND COVER SHOWN


- D. Provide owner with complete list of instructions for continued care.
- 5. PLAN IS DIAGRAMMATIC AND MEASUREMENTS SHOULD BE CONFIRMED ON-SITE. ANY CHANGESARE THE RESPONSIBILITY OF THE CONTRACTOR TO COORDINATE WITH THE OWNERS REPRESENTATIVE


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PLANTING

- 1. PLANT MATERIAL TO BE PROVIDED IN ACCORDANCE WITH SPECIES, SIZES AND QUANTITIES INDICATED BELOW. SUBSTITUTIONS TO BE MADE WITH THE APPROVAL OF LANDSCAPE ARCHITECT. 2. NO PLANTING TO PROCEED UNTIL IRRIGATION SYSTEM IS FULLY FUNCTIONING IN THE AREA TO BE PLANTED.
- 3. ALL PLANT HOLES TO BE DUG 2 TIMES THE VOLUME OF THEIR ROOT BALL SIZE. BACKFILL SHALL CONSIST OF 1/3 ORGANIC MULCH, 2/3 TOP SOIL, MICORRHIZAE SUPPLEMENT AND 16-16-16 FERTILIZER AS FOLLOWS.
- 1 GAL 1 OZ 3-5 GAL 2 OZ LARGER 4 OZ
- 4. PLANT UPRIGHT AND FACE TO GIVE BEST APPEARANCE OR RELATIONSHIP TO PLANTS, STRUCTURES AND PREDOMINANT VIEWING ANGLE. TREES ARE TO BE PLANTED SO AS TO BE STRAIGHT UP AND DOWN
 WITHOUT THE ASSISTANCE OF STAKING. STAKING IS SOLELY FOR SUPPORT AGAINST OUTSIDE FORCES.
- 5. LOOSEN AND REMOVE TWINE BINDING AND BURLAP FROM AROUND TOP OF EACH ROOT BALL.
- Scarify root balls of plants exhibiting a root bound condition, being careful not to damage the root balls integrity. Stake and guy trees immediately after this work. 6. PLACE AND COMPACT BACKFILL SOIL MIXTURE CAREFULLY TO AVOID INJURY TO ROOTS, AND FILL ALL VOIDS. 7. When hole is 2/3 filled with soil, completely soak and allow water to soak away at least two TIMES OR MORE, AS NECESSARY TO COMPLETELY WATER INDIVIDUAL PLANTS.
- 8. GUARANTEE PLANT MATERIALS AND RELATED WORKMANSHP OF INSTALLATION, BEGINNING AFTER WRITTEN ACCEPTANCE OF WORK, FOR ONE YEAR.
 - A. REPLACE PLANT MATERIAL NOT SURVIVING OR IN POOR CONDITION DURING GUARANTEE PERIOD. B. Perform all replacement work in accordance with original specifications at NO ADDITIONAL COST TO OWNER.
 - C. Damage or loss of plant materials due to vandalism, freezing or acts of neglect byothers, is exempt from Contractor's replacement responsibility



Landscape Design by:

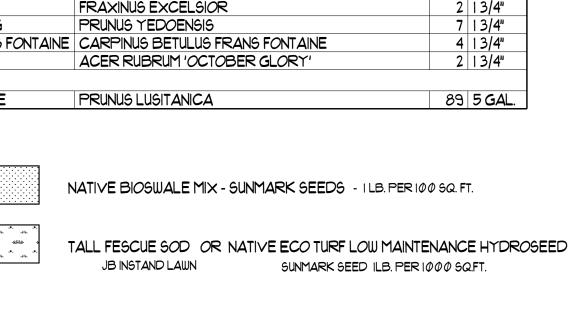FIGUEROA'S LANDSCAPING & CONST., LLC. P.O. BOX 4709 MEDFORD, OR 97501 541-621-8970 FIGULAND@HOTMAIL.COM ADRIANA FIGUEROA LCB:9664 CCB:222017

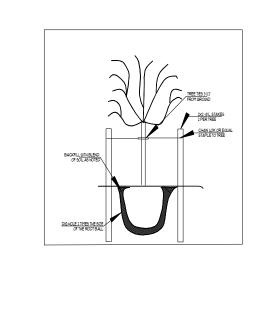Date: 1/27/2025

Landscape Plan:

PACIFIC WALL SYSTEMS

LOCATION: 100 HOUSTON ROAD PHOENIX, OR. 97535 MAP 38-1W-09DC, TAX LOT 3700

PACIFIC WALL SYSTEMS, INC.

1" = 50'

Revision #:

JB STEEL

JB STEEL P.O. BOX 4460 MEDFORD, OR 97501 541-630-3325 TEL 541-773-6523

PLANTING